LEGEND
PAGE 1# COVER PAGE
PAGE 2# SITE PLAN
PAGE 3# LANDSCAPING PLAN
PAGE 4# SITE PLUMBING PLAN
PAGE 5# FLOOR PLAN

PAGE 6# ELEVATIONS PAGE 7# ELEVATIONS



COUNCIL — LAUNCESTON CITY COUNCIL ZONE — GENERAL RESIDENTIAL CODE — SCENIC MANAGEMENT LANDSLIDE BAND — MEDIUM TITLE REF. = 169446/39

LOWER FLOOR AREA = 67.0 sq/m UPPER FLOOR AREA = 99.6 sq/m PRIVATE OPEN SPACE = 99.6 sq/m UPPER FLOOR STAIRS AND LANDING = 11.6 sq/m

WIND CLASSIFICATION N1
DESIGN GUST SPEED (VU) 34M/S

CLIMATE ZONE FOR THERMAL DESIGN = 7
REFER TO ENERGY REPORT BY 2DR

ALPINE AREA - N/A LESS THAN 900m AHD

CORROSION ENVIRONMENT - MODERATE

OTHER HAZARDS - N/A

ALL DIMENSIONS SHOWN ARE TO OUTSIDE CLADDING UNLESS NOTED OTHERWISE

CONFIRM ALL DIMENSIONS AND SERVICES ON SITE PRIOR TO COMMENCEMENT OF WORKS

IF IN ANY DOUBT ABOUT BEARING AND BOUNDARIES SHOWN THEN THESE MUST BE CONFIRMED ONSITE BY A SURVEYOR PRIOR TO SETOUT

ENSURE DRAWINGS USED ONSITE ARE STAMPED 'APPROVED' PLANS BY BUILDING SURVEYOR AND PERMIT AUTHORITY

# PROPOSED UNIT DEVELOPMENT FOR DYNAMIC BUILD PTY LTD AT No. 7 CARTIERE PLACE NEWSTEAD 7250



FOR ALL YOUR DESIGN, DRAFTING AND ENGINEERING NEEDS ACCREDITATION CC565H MEINDERT VAN DER MOLEN 116 ALANVALE RD NEWNHAM 7248

PH 6326 6276

EMAIL: MVCONSULTINGTAS@GMAIL.COM

SOIL AND WATER MANAGEMENT:


DOWNPIPES TO BE CONNECTED INTO COUNCIL STORMWATER AS SOON AS THE ROOF IS INSTALLED


INSTALL AG DRAIN (IF SHOWN) PRIOR TO FOOTING EXCAVATION

EXCAVATED MATERIAL PLACED UP SLOPE OF AG DRAIN. TO BE REMOVED WHEN BUILDING WORKS ARE COMPLETE AND USED AS FILL ON SITE FOR ANY LOW POINTS. INSTALL A SEDIMENT FENCE ON THE DOWNSLOPE SIDE OF MATERIAL

CONSTRUCTION VEHICLES TO BE PARKED ON THE STREET ONLY, TO PREVENT TRANSFERRING DEBRIS ONTO STREET



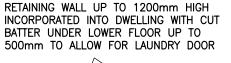

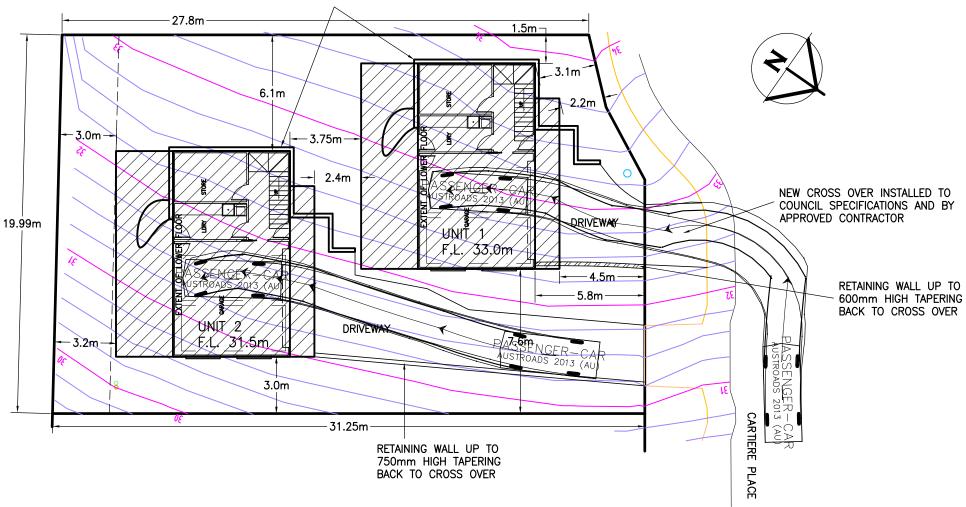

#### **SITE PLAN**

SITE AREA = 606 sq/mROOFED AREA = 200 sq/m SEALED GROUND AREA = 133 sg/m


AREA FREE FROM IMPERVIOUS SURFACES = 273 sq/m 45%

#### **FALL PREVENTION**

WHERE A PERSON IS EXPOSED TO THE HAZARD OF FALLING FROM A STRUCTURE DURING CONSTRUCTION, CLEANING OR MAINTENANCE WORK THE BUILDER SHALL PROVIDE;

- (A) A WORK SYSTEM DESIGNED TO PREVENT SUCH A FALL
- (B) WHERE SAFETY BELT ANCHORAGE POINTS ARE USED THEY MUST BE POSITIONED SUCH THAT THE SAFETY LINE CAN BE ATTACHED BEFORE PROCEEDING TO THE AREA WHERE A FALL IS POSSIBLE
- (C) ANCHORAGE POINTS MUST COMPLY WITH AS2626 AND BE ABLE TO WITHSTAND A FORCE OF 1500KG (D) INFORM THE OWNER PRIOR TO OCCUPANCY THE NATURE OF THE FALL ARREST SYSTEM AND USE ACCORDING TO AS2626.
- MEINDERT VAN DER MOLEN 2017 ( c)

THE DESIGN, DETAILS AND SPECIFICATIONS ON THIS PLAN ARE PROJECT SPECIFIC AND MUST NOT BE USED ON ANY OTHER WITHOUT EXPRESS PERMISSION OF THE AUTHOR.

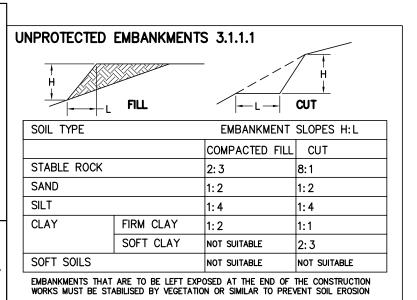

#### **MV CONSULTING (TAS) PTY LTD**

ACCREDITATION CC565H 116 ALANVALE RD NEWNHAM 7248 PH 6326 6276

EMAIL: MVCONSULTINGTAS@GMAIL.COM

PROJECT: PROPOSED UNIT DEVELOPMENT FOR DYNAMIC BUILD PTY LTD

AT No. 7 CARTIERE PLACE NEWSTEAD 7250

REVISION NUMBER	DATE	DRAWING: SITE PLAN
REVISION 1	29 / 06 / 2017	
REVISION 2	03 / 07 / 2017	
REVISION 3	04 / 07 / 2017	DESIGNED: M. v. d. I
REVISION 4	10 / 07 / 2017	DESIGNED: M. V. a. I
		DRAWN: M. v. d. M.


ESIGNED: M. v. d. M. RAWN: M. v. d. M.

APPROVED. DATE: 10 / 07 / 17

SCALE: 1:200.

DRAWING No.: DYN0617 - 2/7



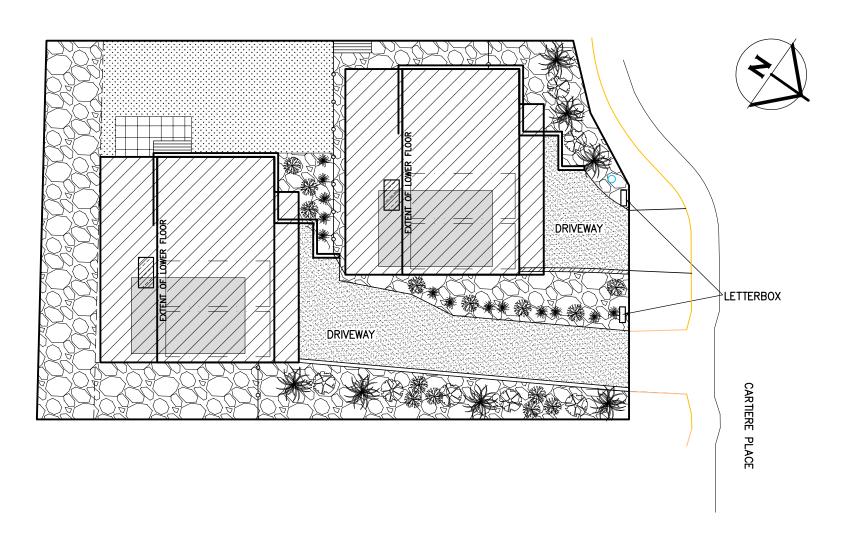





EURYOPS PECTINATUS GOLDEN DAISY BUSH MATURE HEIGHT APPROX. 1.5m

BUXUS SEMPERVIRENS



SUFFRUTICOSA
(DUTCH BOX)
MATURE HEIGHT APPROX. 1.0m
SEDUM SPECTABILE
ICE PLANT
MATURE HEIGHT APPROX. 0.7m



DIANELLA TASMANICA (TASMANIAN FLAX LILY) MATURE HEIGHT APPROX. 1.0m

NOTE: IF SPECIFIED PLANTS ARE NOT AVAILABLE AT TIME OF PLANTING SIMILAR SIZE AND TYPE OF PLANTS SHOULD BE INSTALLED IN LOCATIONS SHOWN.

WHERE REQUIRED GARDEN BEDS TO HAVE AN IRRIGATION SYSTEM. IN-LINE DRIPPER TUBE @ 300crs. TO BE PROVIDED



PAVED OR SIMILAR PATH TO BE PROVIDED FROM DWELLING TO CLOTHES LINE



SIR WALTER BUFFALO OR SIMILAR GRASS



15mm-20mm 'NO FINES' DECORATIVE STONE MULCH TO ALL GARDEN BEDS.



SEALED DRIVEWAY



PRIVATE OPEN SPACE 6x4m ON ROOF SPACE



CLOTHES LINE



WHEELIE BIN STORAGE MINIMUM 1.5sq/m

### MV CONSULTING (TAS) PTY LTD

ACCREDITATION CC565H 116 ALANVALE RD NEWNHAM 7248 PH 6326 6276

EMAIL: MVCONSULTINGTAS@GMAIL.COM

PROJECT: PROPOSED UNIT DEVELOPMENT FOR DYNAMIC BUILD PTY LTD

AT No. 7 CARTIERE PLACE NEWSTEAD 7250

DRAWING: LANDSCAPING PLAN

DESIGNED: M. v. d. M. DRAWN: M. v. d. M.

APPROVED.
DATE: 10 / 07 / 17

SCALE: 1: 200.

DRAWING No.: DYN0617 - 3/7


OTHER WITHOUT EXPRESS PERMISSION OF THE AUTHOR.

Document Set ID: 3598497 Version: 2, Version Date: 17/08/2017

MEINDERT VAN DER MOLEN 2017

THE DESIGN, DETAILS AND SPECIFICATIONS ON THIS PLAN ARE PROJECT SPECIFIC AND MUST NOT BE USED ON ANY



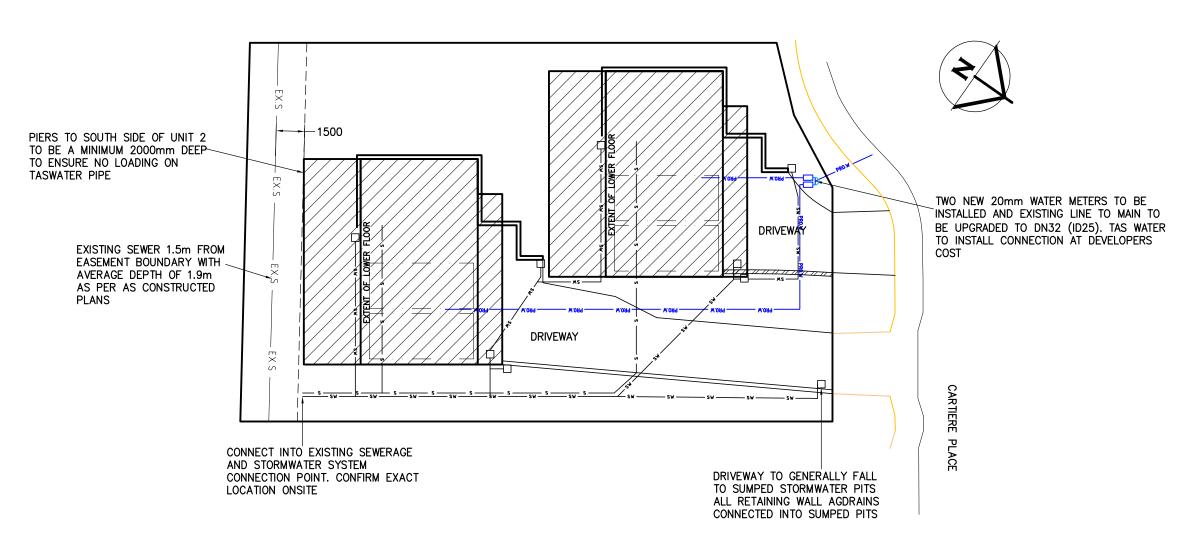

#### **SITE PLUMBING PLAN**

## ALL DRAINAGE WORK TO COMPLY WITH AS3500, TASMANIAN PLUMBING CODE AND LOCAL COUNCIL REQUIREMENTS. LOCATION AND DEPTH OF EXISTING SERVICES TO BE CONFIRMED ONSITE

SEWER BRANCH LINES TO BE DN100 DIA. CLASS SH SOLVENT WELD UPVC, LAID AT MIN GRADE OF 1:60 (1.65%). WATER CLOSET LINE DN100 DIA. CLASS SH SOLVENT WELD UPVC, MIN GRADE 1:60 SHOWER, BASIN, SINK, TROUGH LINES DN50 DIA. CLASS SH SOLVENT WELD UPVC, MIN GRADE 1: 40 (2.5%)

MIN GRADE 1: 40 (2.5%)
STORM WATER BRANCH LINES TO BE DN90 DIA
CLASS SH SOLVENT WELD UPVC, LAID AT MIN GRADE OF 1:60

# MV CONSULTING (TAS) PTY LTD ACCREDITATION CC565H

ACCREDITATION CC565H 116 ALANVALE RD NEWNHAM 7248 PH 6326 6276

EMAIL: MVCONSULTINGTAS@GMAIL.COM

PROJECT: PROPOSED UNIT DEVELOPMENT FOR DYNAMIC BUILD PTY LTD

AT No. 7 CARTIERE PLACE NEWSTEAD 7250

DRAWING: SITE PLUMBING PLAN

| REVISION NUMBER | DATE | | DRAWING: STIE PLUMBING PLAN | REVISION 2 | 03 / 07 / 2017 | REVISION 3 | 04 / 07 / 2017 | DESIGNED: | M | V | d | M | ADDITION | ADDITION | M | V | d | M | ADDITION | ADDITION | M | V | d | M | ADDITION | ADDITION | M | V | d | M | ADDITION | ADDITION | ADDITION | M | V | d | M | ADDITION | ADDITION | ADDITION | M | V | d | M | ADDITION | ADDITION | M | V | d | M | ADDITION |

REVISION 4

DESIGNED: M. v. d. M. APPROVED. DATE: 10 / 07 / 17

SCALE: 1: 200. DRAWING No.: A3. DYN0617 - 4/7

OTHER WITHOUT EXPRESS PERMISSION OF THE AUTHOR.

Document Set 1D: 3598497


Version: 2, Version Date: 17/08/2017


MEINDERT VAN DER MOLEN 2017

THE DESIGN, DETAILS AND SPECIFICATIONS ON THIS PLAN


ARE PROJECT SPECIFIC AND MUST NOT BE USED ON ANY



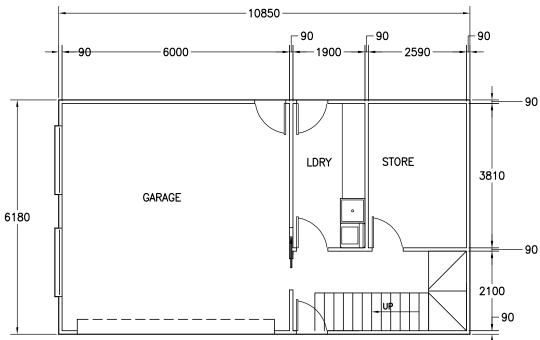

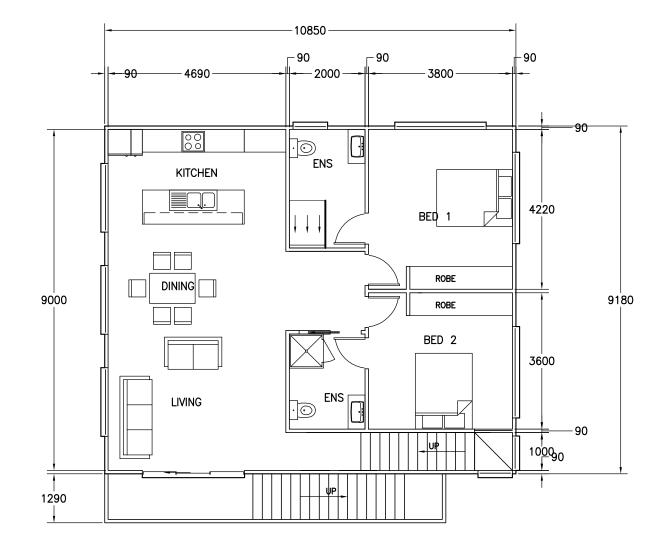



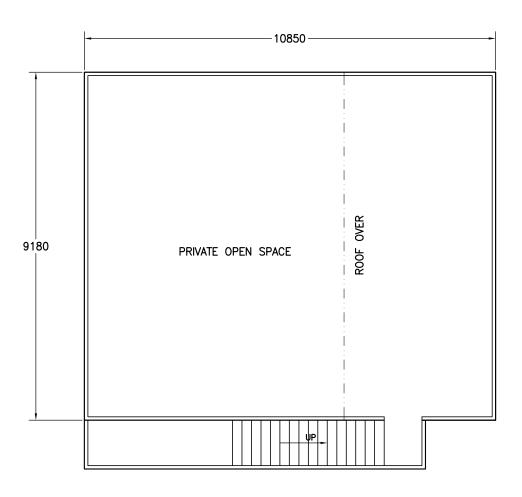

#### PROPOSED FLOOR PLAN

LOWER FLOOR AREA = 67.0 sq/m UPPER FLOOR AREA = 99.6 sq/m PRIVATE OPEN SPACE = 99.6 sq/m UPPER FLOOR STAIRS AND LANDING = 11.6 sq/m

## MV CONSULTING (TAS) PTY LTD

ACCREDITATION CC565H 116 ALANVALE RD NEWNHAM 7248 PH 6326 6276

EMAIL: MVCONSULTINGTAS@GMAIL.COM

PROJECT: PROPOSED UNIT DEVELOPMENT FOR DYNAMIC BUILD PTY LTD

DYNAMIC BUILD PTY LTD AT No. 7 CARTIERE PLACE NEWSTEAD 7250

NEWSTEAD 7250

DRAWING	DATE 29 / 06 / 2017		REVISION REVISION
	03 / 07 / 2017	2	REVISION
DESIGNED	04 / 07 / 2017	3	REVISION
	10 / 07 / 2017	4	REVISION
DRAWN:			
D117111111			
SCALE:			
00,			

DRAWING: FLOOR PLAN

DESIGNED: M. v. d. M. DRAWN: M. v. d. M.

APPROVED.
DATE: 10 / 07 / 17

SCALE: 1:100.

DRAWING No.: DYN0617 - 5/7


OTHER WITHOUT EXPRESS PERMISSION OF THE AUTHOR.

Document Set ID: 3598497


Version: 2, Version Date: 17/08/2017

MEINDERT VAN DER MOLEN 2017

THE DESIGN, DETAILS AND SPECIFICATIONS ON THIS PLAN ARE PROJECT SPECIFIC AND MUST NOT BE USED ON ANY

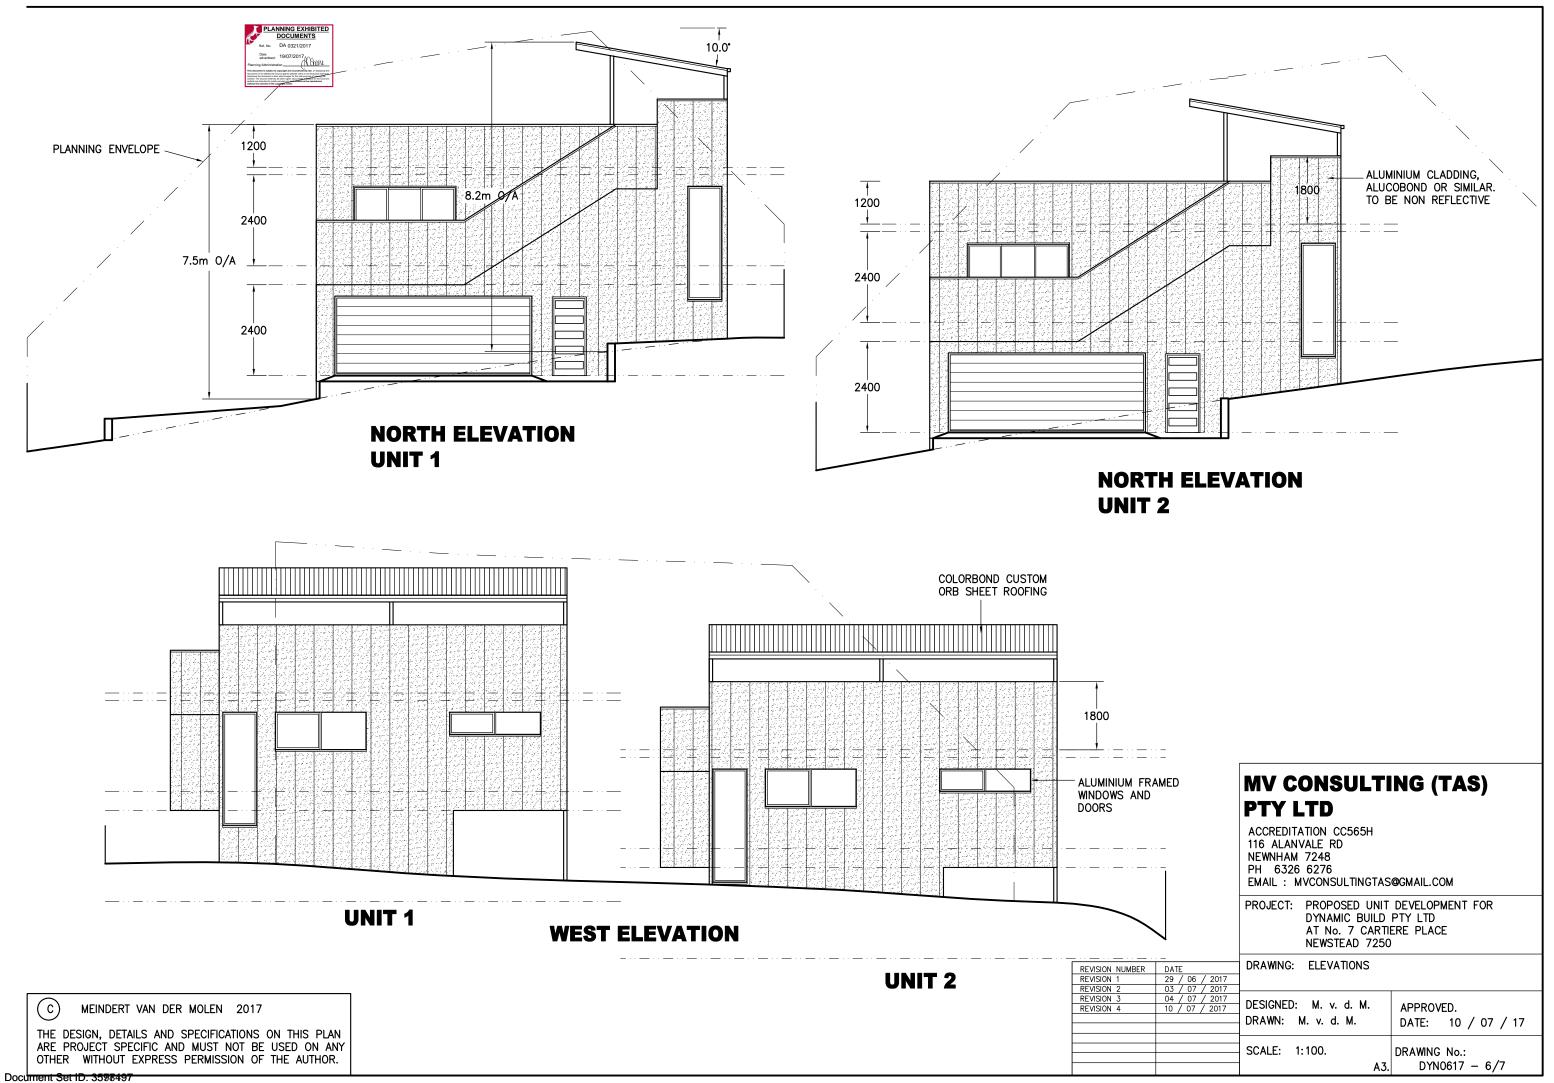

Version: 2, Version Date: 17/08/2017

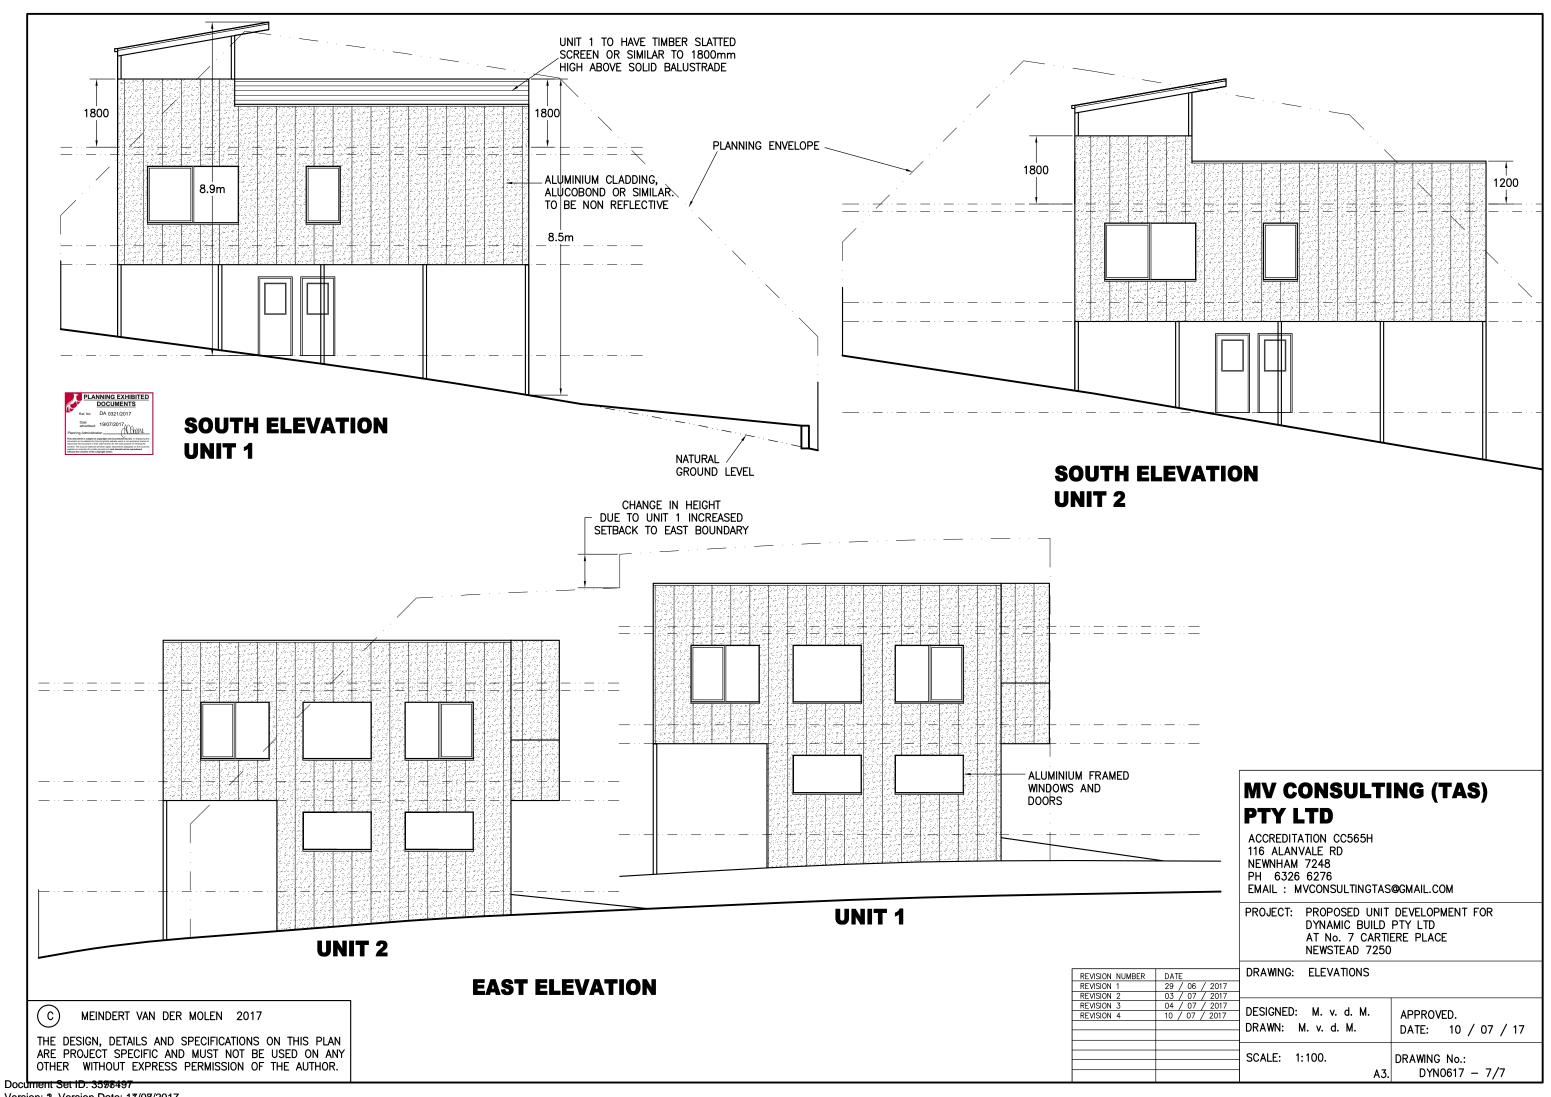

Version: 2, Version Date: 17/08/2017