# Drawing Transmittal

GG Project Number: JBH200758

Project Location:

Project Name: JB HI-FI Launceston

HOME STORE
78 Lindsay Street

Invermay, TAS, 7248, Australia

#### **PROJECT CONTACTS**

PROJECT PM:	Matthew Healy
	Ph: 0407 853 102
DESIGNER:	Rachel Moon
	Ph: (03) 8610 8359
CONSTRUCTION PM:	-
	Ph: -

#### Please find enclosed the following drawings:

JBH200758 Launceston	\TE	MONTH	01													
Launceston	7	MONIN	03													
		YEAR	16													
SHT TITLE		RE	VISI	ON												
00 TRANSMITTAL / COV	√ER		Α													
06 PROPOSED SHOPFR	RONT	DESIGN	Α													

00 TRANSMITTAL / COVER	А								
06 PROPOSED SHOPFRONT DESIGN	A								

### **REVISION COMMENTS:**

Proposed shopfront elevations for planning permit application issued

DISTRIBUT	ION FI21	DISTRIBUT	1014 /411		.J. L'-L/V(/	11LD, 1-17	ΛLD, I -	. 031	JI 123, 1 C	,-i	DISC		
JB HI-FI	Michael Pedley	E											
	Matthew Healy	E											
	Stuart Leach	-											
	Christie Dichmann	-											
COUNCIL	Michelle OLeary	E											
CERTIFIER	Name	-											
													$\top$

LAUNCESTON (TAS.)



#### JB HI-FI SPECIFIC CONSTRUCTION NOTES

- ALL WALLS TO BE FINISHED IN TAUBMANS 'CHAMPAGNE COCKTAIL' UNLESS OTHERWISE NOTATED.
  REFER TO NATIONAL PAINT SPECIFICATION FOR COAT DESCRIPTION
- DROP-IN CEILING TILE DETAILS AS FOLLOWS:


MANUFACTURER: ARMSTRONG
STYLE: FINE FISSURED/MEDIUM TEXTURE 3570

(1200 x 600) 24mm SQUARE LAY-IN CEILING TILES TO EXTENTS AS SPECIFIED ON SHEET NO.04 REFLECTED CEILING PLAN


- ALL GPO'S TO BENCHES ARE TO BE MOUNTED UNDER THE BENCH TOP UNLESS OTHERWISE SPECIFIED ON SHEET NO.05
- PROPOSED ELECTRICAL PLAN

   RETAIL FLOOR FINISH TO CONSIST OF ONE OF THE FOLLOWING:
  TIMBER FLOOR TO BE 2400 x 1200mm 17MM CD PLY SHEETS
  SCREW FIXED TO TIMBER BATTENS WITH ARISED EDGES AND 4
- COATS OF TUNG OIL OVER

   EXISTING CONCRETE FLOOR SLAB TO BE GROUND BACK (IF REQUIRED) AND SANDED, FOLLOWED BY APPLICATION OF A GROUT AND DENSIFYING SOLUTION THEN POLISHING

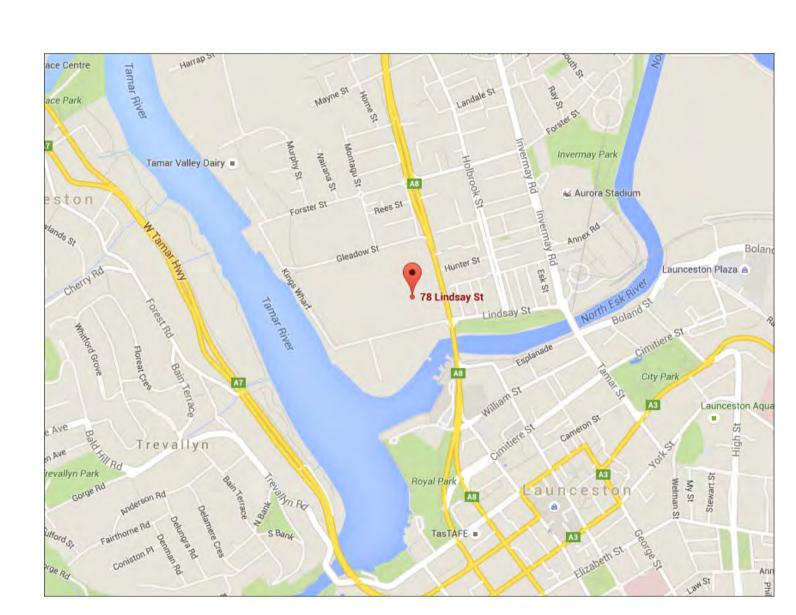



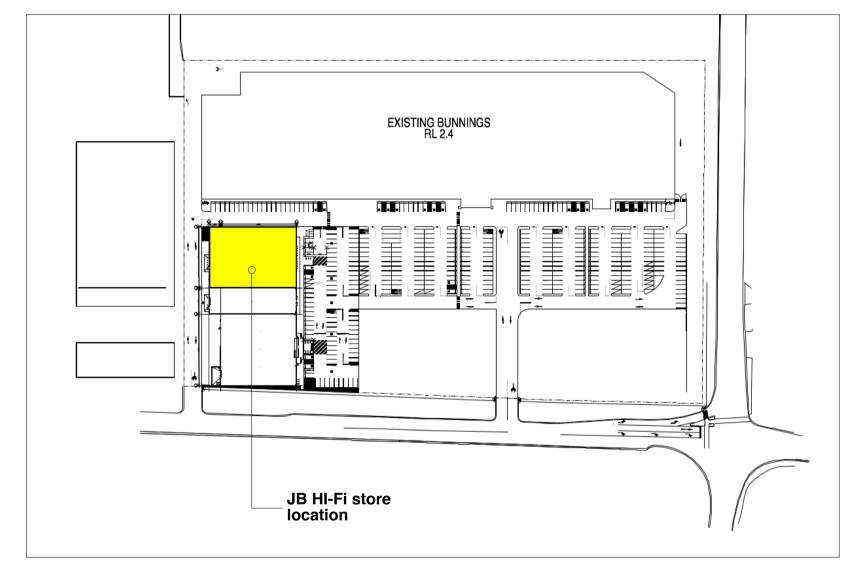

SITE PLAN (NTS)



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GENERAL AND CONSTRUCTION NOTES:

• CONTRACTORS ARE TO VERIFY ALL DIMENSIONS AND LEVELS ON SITE PRIOR TO COMMENCING ANY WORKS.

• FIGURED DIMENSIONS TAKE PRECENDENCE OVER SCALED DIMENSIONS.

• RIGURED DIMENSIONS TAKE PRECENDENCE OVER SCALED DIMENSIONS.

• ALL MATERIALS, FINISHES AND BUILDING WORKS MUST BE AS SPECIFIED. REFER TO SEPARATE WALL AND FLOOR FIXTURE DRAWINGS FOR DETAILS. ANY AMENDMENTS MUST BE APPROVED IN WRITING BY GREATER GROUP.

• GLAZING TO BE IN ACCORDANCE WITH AS, 1288-1994 & TABLE 12 OF THE BUILDING CODE OF AUSTRALIA/NZS 4223. ALL EDGES TO BE ARISSED AND ALL EXPOSED EDGES POLISHED WITH A RADIUS OF AT LEAST. 5MM UNLESS OTHERWISE SPECIFIED.

• WET AREAS TO BE IMPERVIOUS TO WATER. WALL SURFACES BEHIND ANY BASIN, SINK ETC OF A WALL TO A HEIGHT OF 300MM ABOVE THE FIXTURE. WATERPROPOPING TO WET AREAS TO COMPTY WITH AS, 3740/23 OF THE NEW ZEALAND BUILDING CODE.

• ALL DOORWAYS TO HAVE A MINIUM UN-OBSTRUCTED HEIGHT OF 2.1M. THE MINIMUM WIDTH OF NEW DOORWAYS NOT TO BE LESS THAN 850MM.

• ALL SIT DOORS AND DOORS IN THE PATH OF TRAVEL TO EXITS ARE TO BE CAPABLE OF BEING OPENED AT ALL HIMES FROM THE SIDE FACING A PERSON SEEKING EGRESS FROM THE BUILDING WITH A SINGLE HANDED DOWNWARD OR PUSHING ACTION ON A SINGLE DEVICE WITHOUT THE USE OF A KEY AND LOCATED BETWEEN 900MM AND 1200MM ABOVE FLOOR LEVEL IN ACCORDANCE WITH CLAUSE D2.21 OF THE BUILDING CODE OF AUSTRALIA/D1 OF THE NEW ZEALAND BUILDING CODE.

• EXIT SIGNS AND EMERGENCY LIGHTS TO COMPLY WITH AS/NZS 2293 - 2003. ARTIFICIAL LIGHTING IN ACCORDANCE WITH AS.1680 - 1998 / PART 136.

• EXTINIOUISHERS IN ACCORDANCE WITH AS.2444-2001 AND CLAUSE E1.6 OF THE BUILDING CODE OF AUSTRALIA, RELEVANT CODES OF THE NEW ZEALAND BUILDING CODE.

• AUTOMATIC SMOKE DETECTION AND ALARM SYSTEMS TO COMPLY WITH APPENDIX C AS.2118.1 / RELEVANT CODES OF THE NEW ZEALAND BUILDING CODE.

• AUTOMATIC SMOKE DETECTION AND ALARM SYSTEMS TO COMPLY WITH SPECIFICATION E2.2A OF THE BCA / RELEVANT CODES OF THE NEW ZEALAND BUILDING CODE OF AUSTRALIA, RELEVANT CODES OF THE NEW ZEALAND BUILDING C

REVISIONS

	#	Amendment:	Init:	Date:	
LS. ED	Α	Proposed shopfront elevations for planning permit application issued	RM	01/02/16	ISSUE:
HE					PLANNIN(
M. A HE IG					JB HI-FI
RT					Launceston
W IG					HOME STORE
W IG					
W					78 Lindsay Street, Invermay, TAS, 7248, Australia

JB HI·FI [HOME]


**PLANNING PERMIT** 


DRA
TRA


DRAWING:

TRANSMITTAL/COVER-PP

	<b>ME:</b> /Volumes/Design/JB Hi-Fi (2)/JB301 (JBH200758) Laur Inceston (V19) D.pln	nceston (Hom	e) TAS./0
Date:	1/03/2016	Drawn:	IQ
Scale:	Scale as shown @ A1	Size:	A1
GG Project:	JBH200758	Rev by:	RM
Sheet:	00	Rev:	Α

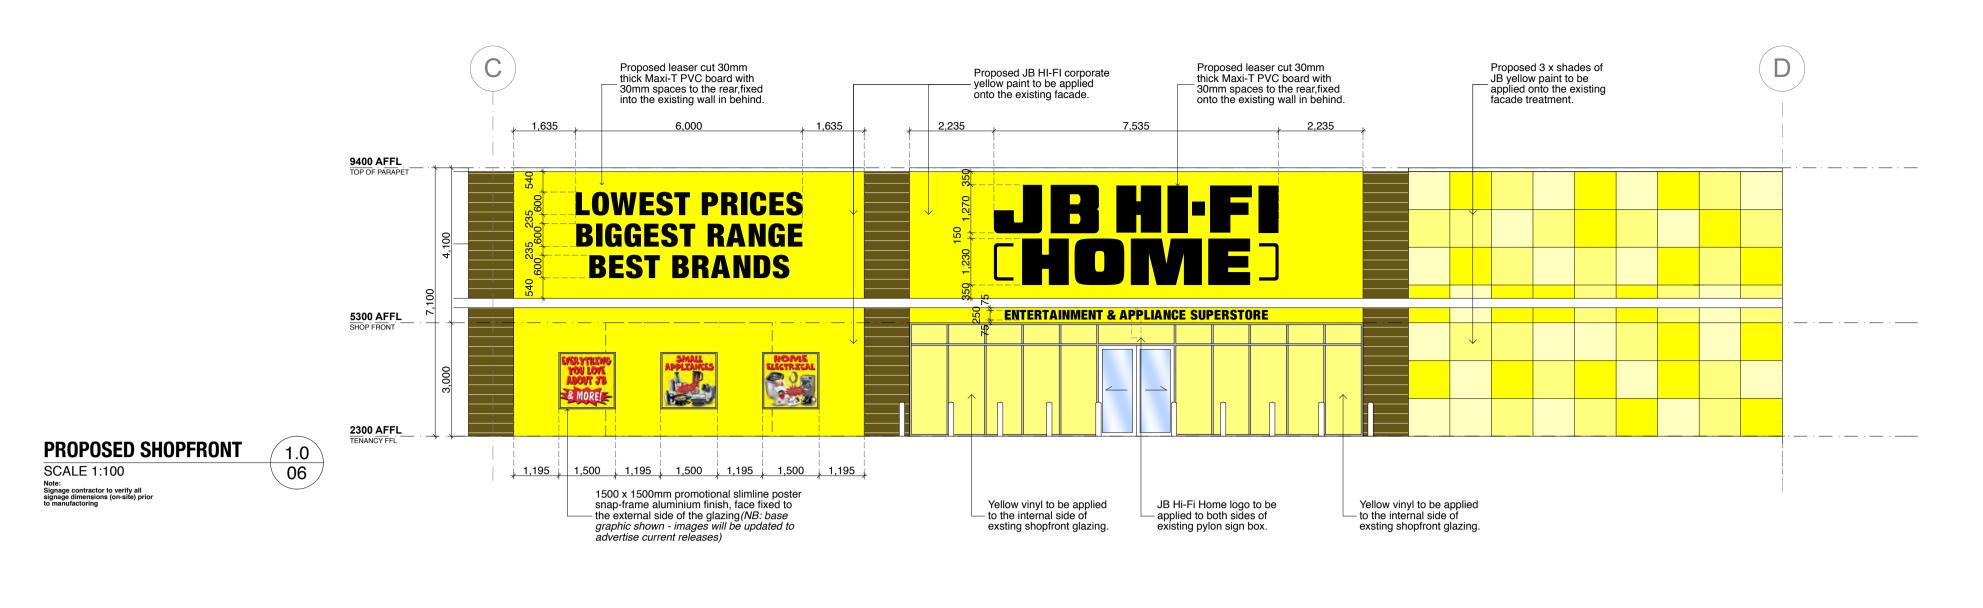

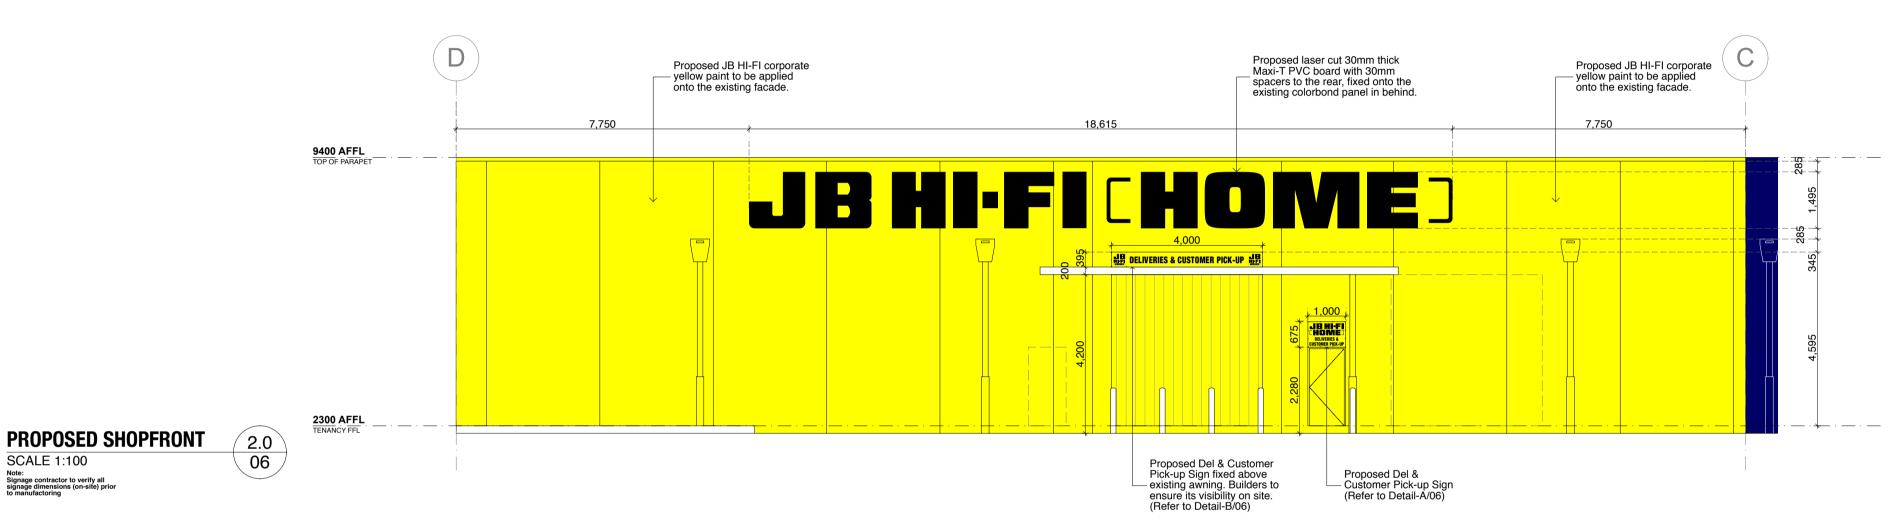

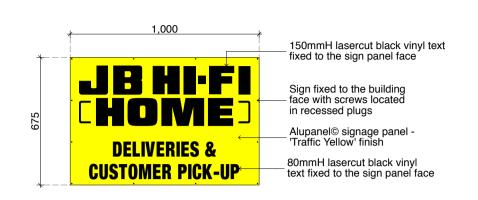


PROP. DEL. & CUSTMER
PICK-UP SIGN DETAILS

SCALE 1:20


NOTE:

• Alupanel© 'Traffic Yellow' signage panel with 175mm high black 'JB Hi-Fi' logo text including 105mm high black 'DELIVERIES & CUSTOMER PICK-UP' lettering.

Lettering to be direct stick vinyl.Sign face fixed to above receiving door.

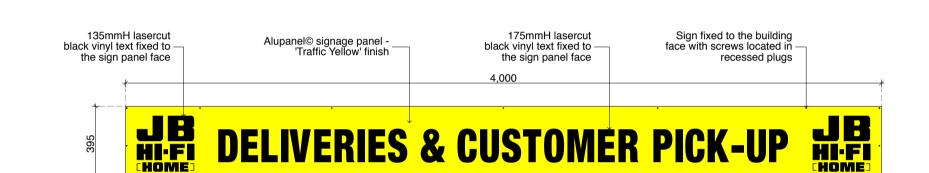



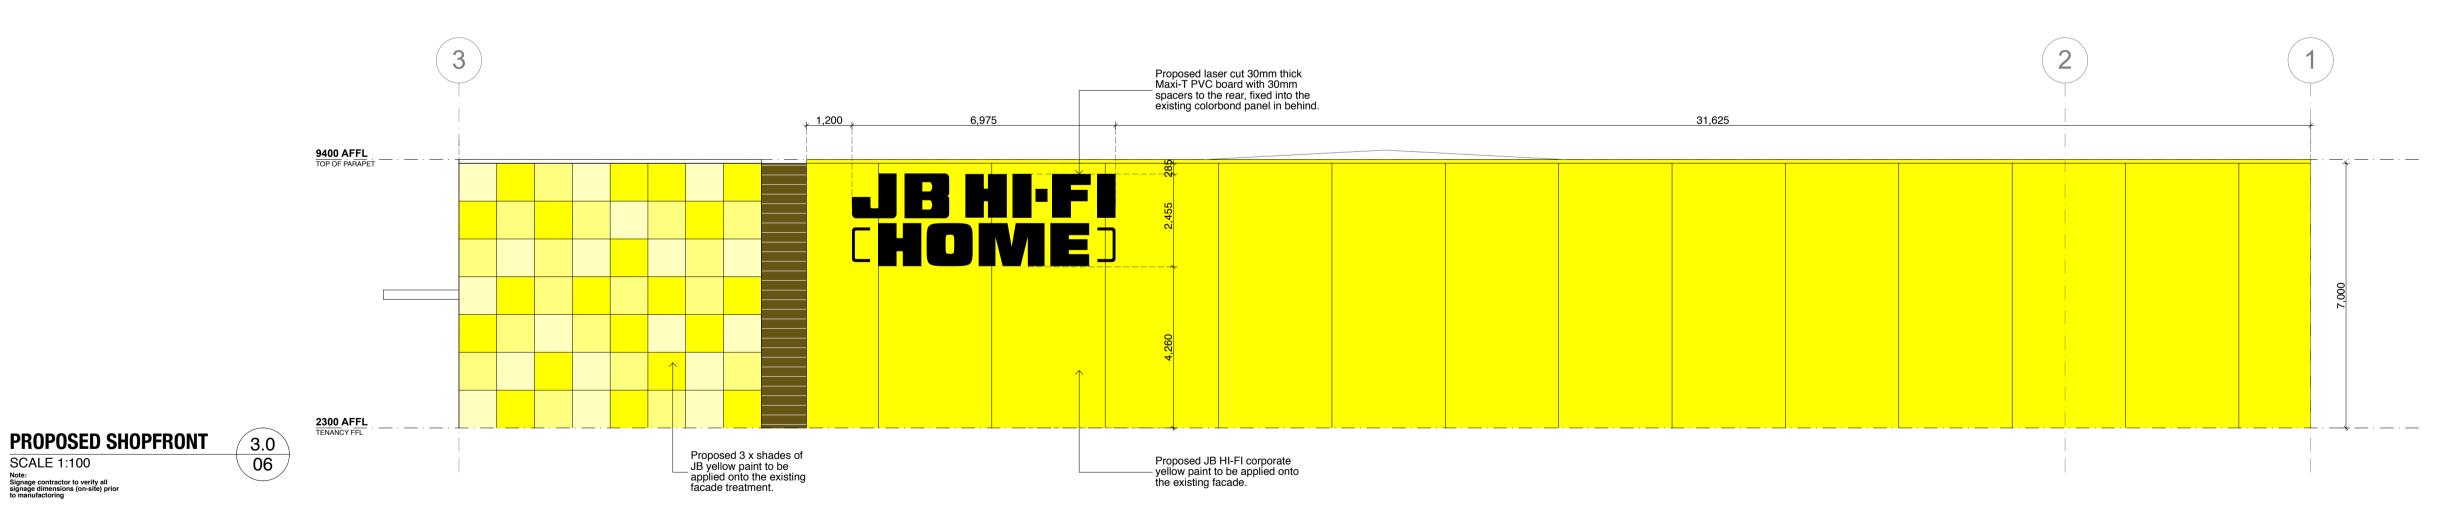

## greater group

 sydney
 level 2, johnson's building, 225-229 george street, NSW 2000, australia p | +61 (0)2 9221 2999 f | +61 (0)2 9223 5849

 melbourne
 ground level, 700 collins street, docklands, VIC 3008, australia p | +61 (0)3 8610 8300 f | +61 (0)3 8610 8388

 shanghai
 no. 10, lane 201, fuxing rd, xuhui district, shanghai 200031, china p.r.c. p | +86 21 5465 7179 f | +86 21 5465 8810

 www.greatergroup.com.au
 info@greatergroup.com.au

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Jb A W	GENERAL AND CONSTRUCTION NOTES:  • CONTRACTORS ARE TO VERIFY ALL DIMENSIONS AND LEVELS ON SITE PRIOR TO COMMENCING ANY WORKS.  • FIGURED DIMENSIONS TAKE PRECENDENCE OVER SCALED DIMENSIONS.  • ALL MATERIALS, FINISHES AND BUILDING WORKS MUST BE AS SPECIFIED. REFER TO SEPARATE WALL AND FLOOR FIXTURE DRAWINGS FOR DETAILS.  ANY AMENDMENTS MUST BE APPROVED IN WRITING BY GREATER GROUP.  • GLAZING TO BE IN ACCORDANCE WITH AS.1288-1994 & TABLE J2 OF THE BUILDING CODE OF AUSTRALIA/NZS 4223. ALL EDGES TO BE ARISSED AND ALL EXPOSED EDGES POLISHED WITH A RADIUS OF AT LEAST 5MM UNLESS OTHERWISE SPECIFIED.  • WET AREAS TO BE IMPERVIOUS TO WATER. WALL SURFACES BEHIND ANY BASIN, SINK ETC OF A WALL TO A HEIGHT OF 300MM ABOVE THE	
uilding, 225-229 george street, NSW 2000, australia 21 2999 f   +61 (0)2 9223 5849	FIXTURE. WATERPROOFING TO WET AREAS TO COMPLY WITH AS,3740/E3 OF THE NEW ZEALAND BUILDING CODE.  • ALL DOORWAYS TO HAVE A MINIUM UN-OBSTRUCTED HEIGHT OF 2.1M. THE MINIMUM WIDTH OF NEW DOORWAYS NOT TO BE LESS THAN 850MM.  • ALL EXIT DOORS AND DOORS IN THE PATH OF TRAVEL TO EXITS ARE TO BE CAPABLE OF BEING OPENED AT ALL TIMES FROM THE SIDE FACING A PERSON SEEKING EGRESS FROM THE BUILDING WITH A SINGLE HANDED DOWNWARD OR PUSHING ACTION ON A SINGLE DEVICE WITHOUT THE USE OF A KEY AND LOCATED BETWEEN 900MM AND 1200MM ABOVE FLOOR LEVEL IN ACCORDANCE WITH CLAUSE D2.21 OF THE BUILDING CODE OF AUSTRALIA/D1 OF THE NEW ZEALAND BUILDING CODE.  • EXIT SIGNS AND EMERGENCY LIGHTS TO COMPLY WITH AS/NZS 2293 - 2003. ARTIFICIAL LIGHTING IN ACCORDANCE WITH AS.1680 - 1998 / PART J6.	
, 700 collins street, docklands, VIC 3008, australia 10 8300 f   +61 (0)3 8610 8388	EXTINGUISHERS IN ACCORDANCE WITH AS.2444-2001 AND CLAUSE E1.6 OF THE BUILDING CODE OF AUSTRALIA / RELEVANT CODES OF THE NEW ZEALAND BUILDING CODE.      AUTOMATIC SMOKE DETECTION AND ALARM SYSTEMS TO COMPLY WITH SPECIFICATION E2.2A OF THE BCA / RELEVANT CODES OF THE NEW ZEALAND BUILDING CODE.      AUTOMATIC SMOKE DETECTION AND ALARM SYSTEMS TO COMPLY WITH SPECIFICATION E2.2A OF THE BCA / RELEVANT CODES OF THE NEW ZEALAND BUILDING CODE.      FIRE HAZARD PROPERTIES OF MATERIALS, LININGS AND SURFACE FINISHES TO COMPLY WITH SPECIFICATION C1.10 + C1.10a OF THE BUILDING.	
e 201, fuxing rd, xuhui district, shanghai 200031, china p.r.c. 465 7179 f   +86 21 5465 8810	CODE OF AUSTRALIA/RELEVANT CODES OF THE NEW ZEALAND BUILDING CODE.  • ELECTRICAL INSTALLATION TO COMPLY WITH AS.3000/AMNDT2 / NZS 3000. ALL LIGHTING FIXTURES AND FITTINGS TO BE 'C' TICK APPROVED. LOW VOLTAGE LIGHTS MUST USE APPROVED ELECTRONIC TRANSFORMERS  • ILLUMINATED SIGNAGE WIRING TO COMPLY AUSTRALIAN STANDARDS AND LOCAL AUTHORITY CODES, 240 VOLTS  • LAMP COLOUR TEMPERATURE TO BE 3000K UNLESS SPECIFIED OTHERWISE  • MECHANICAL VENTILATION SYSTEM TO COMPLY WITH AS.1668.2 AND AS.3666 / NZS 1688.2 FOR EXTRACTS AND AS 3666 / NZS 4303 - 1990 FOR	
info@greatergroup.com.au	FRESH AIR. ALL MECHANICAL AND FIRE SERVICES TO BE APPROVED BY THE APPROPRIATE AUTHORITY.  • STRUCTURAL PROVISIONS TO COMPLY WITH CLAUSE B1.2 OF BUILDING CODE OF AUSTRALIA / B1 OF THE NEW ZEALAND BUILDING CODE	

BE NO					
	#	Amendment:	Init:	Date:	
ETAILS.	Α	Preliminary layout issued.	RM	30/11/15	IS
/E THE	В	Alterations to fixtures and categories to accommodate site audit details by JB Hi-Fi (Rec. 08/01/16) Mezzanine level has been removed & changes made to B.O.H layout as per revised plan supplied by JB Hi-Fi (Rec. 11/01/16)	RM	18/01/16	
OMM. ING A UT THE LDING	С	Additional toilet included as per details provided by JB Hi-Fi (Rec. 18/01/16)	RM	29/01/16	
/ PART	D	Services details(Mechanical & FHR) incorporated as per details provided by TMG Grp. (Rec. 11/02/16)	RM	12/02/16	`
E NEW LDING	Е	Smoke detector locations incorporated as per details provided by TMG Grp. (Rec. 17/02/16)	RM	18/02/16	•
E NEW LDING	F	Alterations to fixtures and categories as per details by JB Hi-Fi (Rec. 24/02/16)	RM	01/03/16	_
. LOW					/
0 FOR					

	CLIENT:	JB HI·FI	
•		[ <b>HOME</b> ]	
5	ISSUE:		

	DRAWING:
- 1	PROPOSED SHOPFRONT DESIGN

15 ISSUE: CONSTRUCTION	CAD FILE NAME: /Volumes/Design/JB Hi-Fi (2)/JB301 (JBH200 Model/JB Launceston (V19) D.pln	758) Launceston (Home) TAS./01
CONSTRUCTION	<b>Date:</b> 1/03/2016	Drawn: IQ
JB HI-FI	Scale: Scale as shown @ A1	Size: A1
HOME STORE	GG Project: JBH200758	Rev by: RM
78 Lindsay Street, Invermay, TAS, 7248, Australia	Sheet: 06	Rev: B

