

PROPOSED UNIT DEVELOPMENT

FOR: CHRIS REISSIG BUILDERS

LOT: 20, NO. 5

LEGGES CRESCENT

PROSPECT

DRAWING SHEETS ATTACHED		
SHEET 1	COVER SHEET	
SHEET 2	SURVEY EXTRACT	
SHEET 3	SITE PLAN	
SHEET 4	PLANNING COMPLIANCE	
SHEET 5	SITE SECTION	
SHEET 6	PLUMBING PLAN	
SHEET 7	FLOOR PLAN	UNIT 1
SHEET 8	ELEVATIONS	UNIT 1
SHEET 9	ELEVATIONS	UNIT 1
SHEET 10	SECTION A - A	UNIT 1
SHEET 11	SECTION ENLARGEMENT	UNIT 1
SHEET 12	SETOUT PLAN	UNIT 1
SHEET 13	WINDOW SCHEDULE	UNIT 1
SHEET 14	ENERGY EFF / INSULATION PLAN	UNIT 1
SHEET 15	LIGHTING PLAN	UNIT 1
SHEET 16	ROOF PLAN	UNIT 1
SHEET 17	FLOOR PLAN	UNIT 2
SHEET 18	ELEVATIONS	UNIT 2
SHEET 19	ELEVATIONS	UNIT 2
SHEET 20	SECTION A - A	UNIT 2
SHEET 21	SECTION ENLARGEMENT	UNIT 2
SHEET 22	SETOUT PLAN	UNIT 2
SHEET 23	WINDOW SCHEDULE	UNIT 2
SHEET 24	ENERGY EFF / INSULATION PLAN	UNIT 2
SHEET 25	LIGHTING PLAN	UNIT 2
SHEET 26	ROOF PLAN	UNIT 2
SHEET 27	GENERAL NOTES	_
SHEET 28	WET AREA NOTES - A	
SHEET 29	WET AREA NOTES - B	

SOILTEST REPORT BY tba - CLASS 'tba'	
- tba	
oa	
61556 / 20	
103726	
EN. RESIDENTIAL	
LATIONS - tba	
BAL ASSESSMENT 'BAL LOW' - URBAN D/S	
- MODERATE TO BCA	

AREA DETAILS		
UNIT 1	·	
AREA OF DWELLING	121.03 sqm	TOTAL
AREA OF GARAGE	25.43 sqm	146.46 sqm
AREA OF PORTICO	1.92 sqm	
TOTAL AREA OF DWELLING	148.38 sqm	
UNIT 2	-	
AREA OF DWELLING	102.85 sqm	TOTAL
AREA OF GARAGE	40.60 sqm	143.45 sqm
AREA OF PORTICO	3.12 sqm	
TOTAL AREA OF DWELLING	146.55 sqm	
TOTAL AREA OF DWELLINGS	294.93 sqm	l
LAND SIZE	748 sqm	(APPROX)
SITE COVER	39.43 %	(APPROX)
TOTAL IMPERVIOUS AREA		438.24 sqm
AREA FREE OF IMPERVIOUS	SURFACE	41.40 %
ACCREDITATION - JASON VA	N ZETTEN - (C1952X
_		

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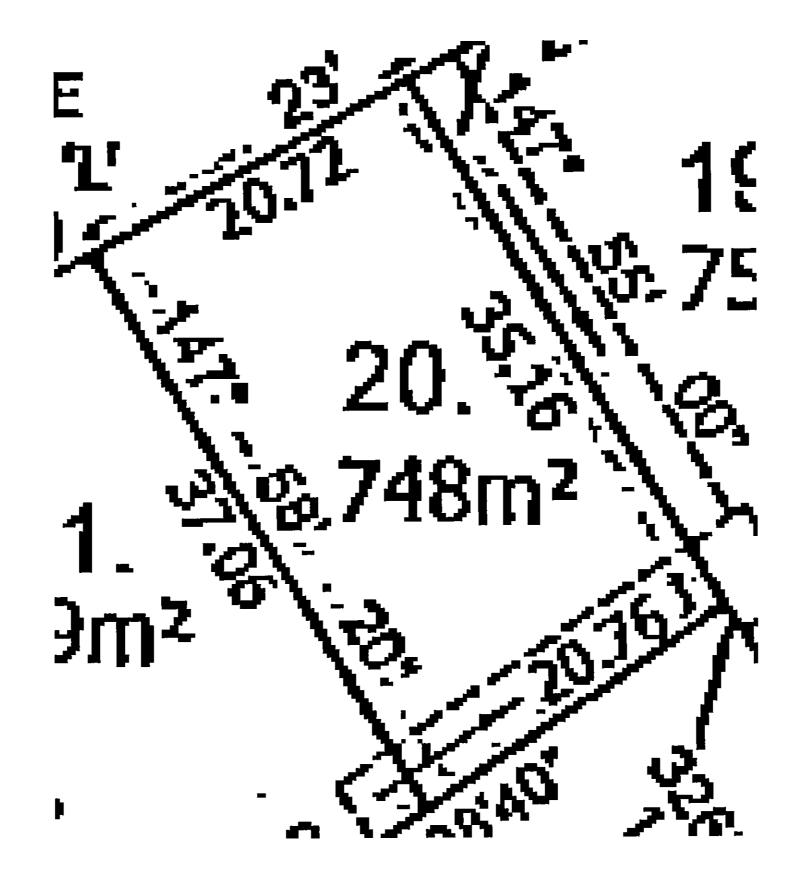


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SURVEY EXTRACT

THE SURVEY EXTRACT ON THIS SHEET IS AS RECIEVED AT THE TIME OF THESE PLANS.
IT IS THE RESPONSIBILITY OF THE OWNER & BUILDER TO CLARIFY ALL DIMENSIONS PRIOR TO COMMENCEMENT OF WORKS ON SITE.
IF ANY DOUBT - CONTACT A SUITABLY QUALIFIED LAND SURVEYOR. ALL SETOUT DIMENSIONS ARE TO BOUNDARIES ONLY.
DO NOT SETOUT FROM FENCES, DRIVEWAYS, ROADWAYS ETC.

SURVEY EXTRACT

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PROPOSED UNIT DEVELOPMENT FOR: CHRIS REISSIG BUILDERS LOT: 20, NO. 5 LEGGES CRESCENT PROSPECT



sheet: 02 OF 29	ISSUE	drawing no: 610
date: DEC 2015	PLANNING	AMENDMENT No
scale: NTS @ A3	PRINT DATE	1.
design: JVZ		2.
drawn: JVZ	2 6 FEB 2016	3.

Jason Van Zetten Acr.cc1952x

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RBAN design solutions





ALL SITE DIMENSIONS ARE TO OUTSIDE CLADDING UNLESS OTHERWISE NOTED

CONFIRM ALL DIMENSIONS ON SITE PRIOR TO COMMENCEMENT OF WORKS

ALL SITE PREPARATION IS TO COMPLY WITH THE BCA

ENSURE FINISHED FLOOR LEVEL IS MIN 150mm ABOVE FINISHED GROUND LEVEL ENSURE FINISHED FLOOR LEVEL OF A CONCRETE SLAB IS POSITIONED SO THAT THE ORG IS 150mm BELOW THE LOWEST PLUMBING FIXTURE AND ABOVE THE GROUND

ALL OTHER MATTERS NOT SPECIFICALLY MENTIONED ARE TO COMPLY WITH THE BCA - IF IN DOUBT ASK

THE BUILDER IS TO PROVIDE PROTECTION TO ADJOINING PROPERTIES AND **BUILDINGS IN ACCORDANCE WITH** THE BUILDING REGULATIONS

NOTE; ALL NEIGHBORING BUILDING LOCATIONS ARE APPROX ONLY; IF FURTHER INFORMATION IS REQUIRED CONSULT A LAND SURVEYOR

THE LEVEL INFORMATION PROVIDED ON THESE PLANS IS LIMITED ONLY AND ONLY TO BE USED FOR THE PURPOSE INTENDED IF FURTHER INFORMATION IS REQUIRED CONSULT SURVEYOR


OUTDOOR CLOTHES DRYING AREA TO BE LOCATED ADJACENT AND ACCESSIBLE FROM LAUNDRY

CONCRETE OR PAVED PATH / DRIVEWAY TO ALL ACCESS DOORS TO DWELLING ALL DRIVEWAYS, PATIOS & PATHS ARE TO BE CONSTRUCTED TO DIRECT SAY AWAY FROM DWELLING @ 1:50 MINIMUM GRADE AND HAVE A MAX STEP HEIGHT OF 180mm

DO NOT SCALE: IF IN DOUBT ASK

UNPROTECTED EMBANKMENTS TO COMPLY WITH PART 3.1 OF BCA VOL. 2 BATTER BACK LESS THAN 45 deg DIRECT ALL STORMWATER

ENSURE AREA OF EXCAVATION IS PROPERLY DRAINED, FROM THE TIME OF EXCAVATION TO ENSURE NO PONDING OF WATER

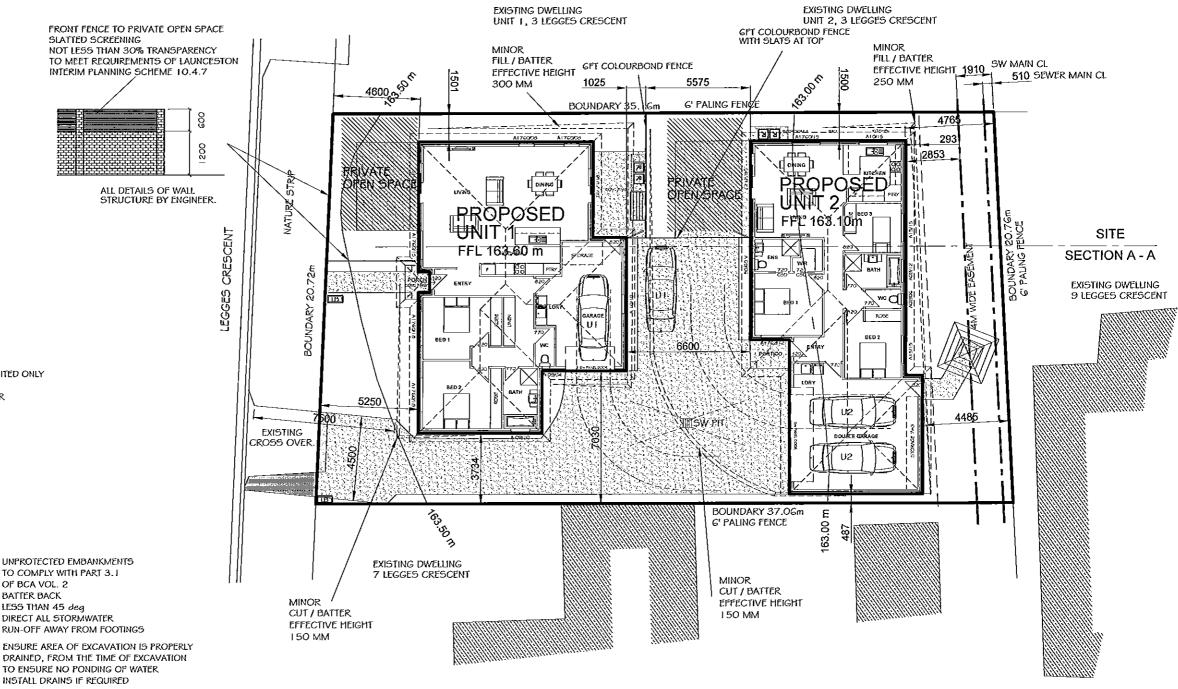

CONTOURS ARE INDICATIVE ONLY, GENERATED FROM LEVELS SPECIFICALLY TAKEN FOR THE PROPOSED BUILDING IN ITS PROPOSED LOCATION THE CONTOURS DO NOT ALLOW FOR LOCAL UNDULATIONS. IF FOR ANY REASON THE DWELLING DOES NOT SUIT THE LEVEL INFORMATION SHOWN, THE PROJECT MANAGER IS TO NOTIFY THE DESIGNER AND BUILDING SURVEYOR AT THE TIME THIS IS DETERMINED.

THE LOCATIONS OF SERVICES INDICATED ON THIS DRAWING ARE INDICATIVE ONLY AND ALL SERVICE LOCATIONS SHOULD BE CONFIRMED PRIOR TO STARTING ON SITE.

SITE PLAN SCALE: 1:200

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PROPOSED UNIT DEVELOPMENT FOR: CHRIS REISSIG BUILDERS LOT: 20, NO. 5 LEGGES CRESCENT PROSPECT




ISSUE sheet: 03 OF 29 drawing no: 6106 **PLANNING** date: DEC 2015 AMENDMENT No. scale: 1:200 @ A3 PRINT DATE 12 6 FEB 20162. design: JVZ drawn: JVZ

Jason Van Zetten Acr.cc1952x

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sheet: 04 OF 29

date: DEC 2015

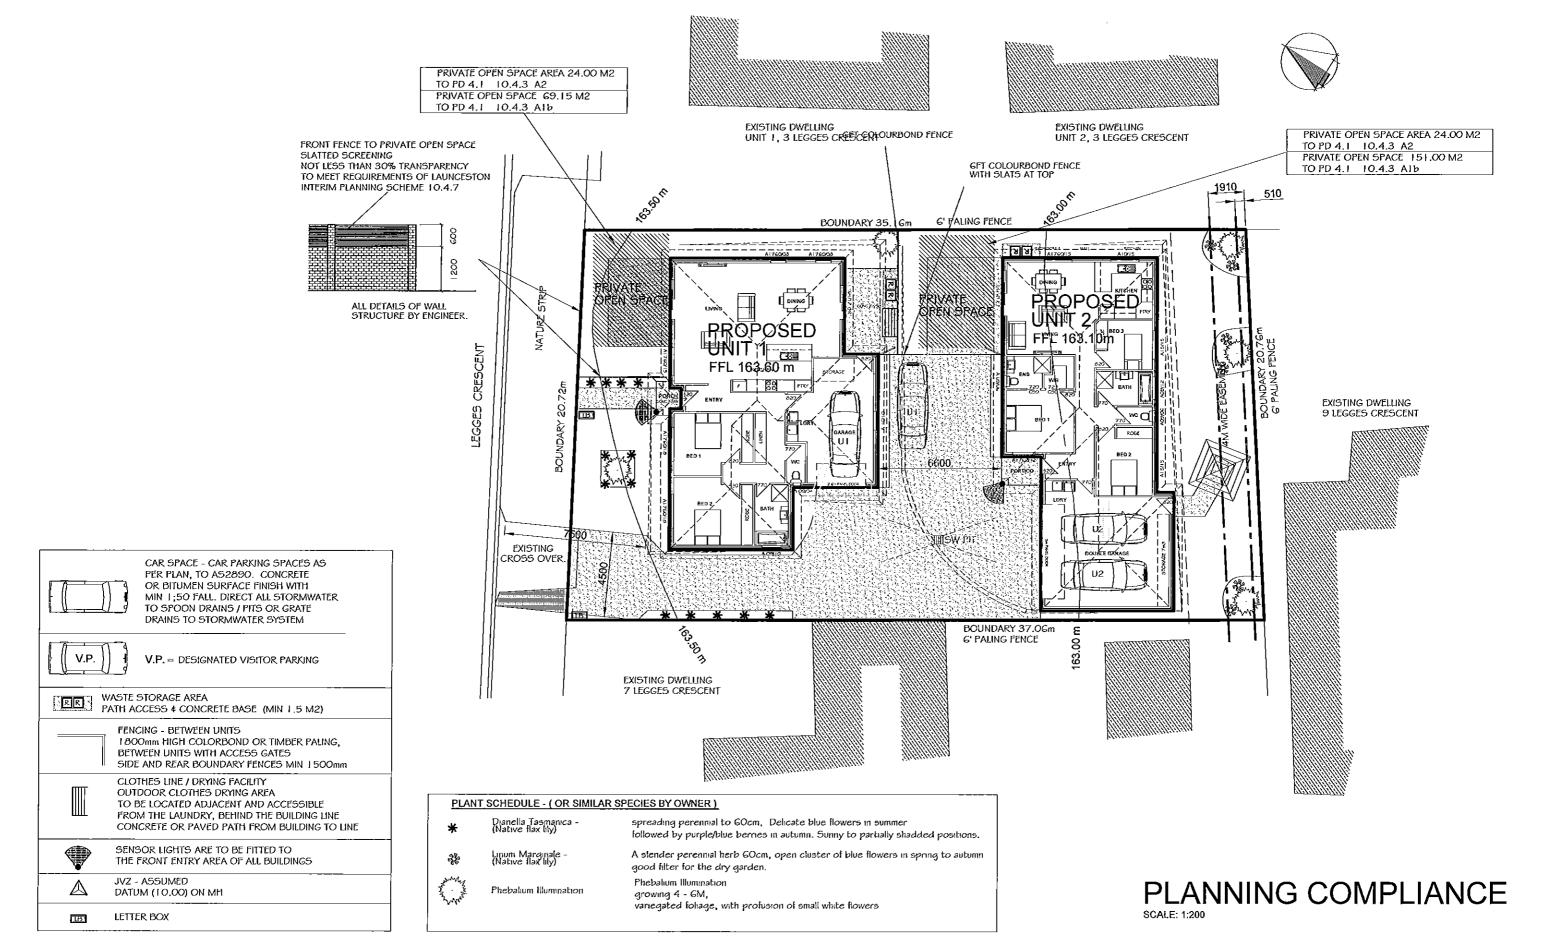PLANNING

AMENDMENT No.


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SITE SECTION A - A

SITE SECTION SCALE: 1:100

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PROPOSED UNIT DEVELOPMENT FOR: CHRIS REISSIG BUILDERS LOT: 20, NO. 5 LEGGES CRESCENT

PROSPECT

PLANNING EXHBIT
DOCUMENTS

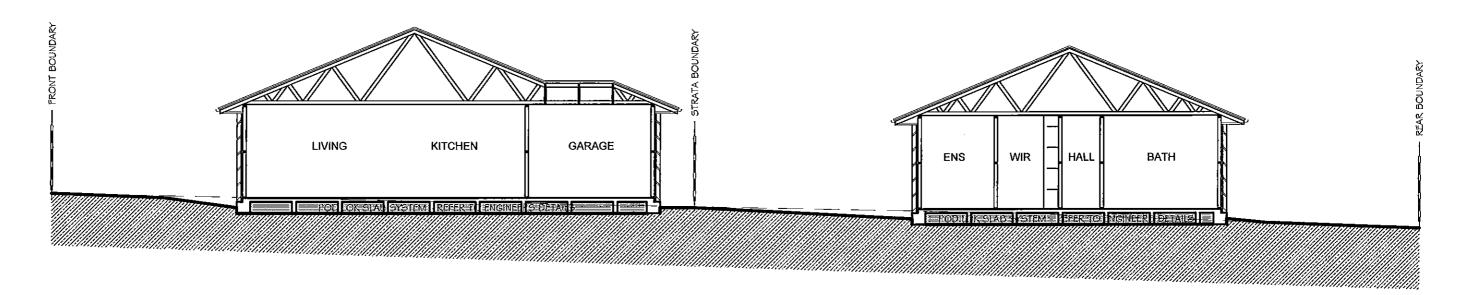Not to DA 00722016

General Grid S020016

Frame Single Grid S020016

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date: DEC 2015
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drawn: JVZ

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CONFIRM ALL DIMENSIONS ON SITE PRIOR TO COMMENCEMENT OF WORKS. THE BUILDER IS TO PROVIDE PROTECTION TO ADJOINING PROPERTIES AND BUILDINGS IN ACCORDANCE WITH THE BUILDING REGULATIONS

THE DOOR OF A FULLY ENCLOSED SANITARY COMPARTMENT MUST OPEN OUTWARDS, SLIDE OR BE READILY REMOVABLE FROM THE OUTSIDE OF THE COMPARTMENT UNLESS THERE IS A CLEAR SPACE OF AT LEAST 1200mm BETWEEN THE CLOSET PAN WITHIN THE SANITARY COMPARTMENT AND NEAREST PART OF THE DOORWAY

ALL OTHER MATTERS NOT SPECIFICALLY MENTIONED ARE TO COMPLY WITH THE BCA - IF IN DOUBT ASK

LEGEND

EXHAUST FAN OR SIMILAR. EXHAUST FANS MUST BE FITTED WITH A SEALING DEVICE / SELF CLOSING DAMPER. DUCT EXHAUST FAN TO EXTERIOR OF BUILDING HARD WIRE TO LIGHT SWITCH TO NON VENTILATED ROOMS



LOCATION OF HARD-WIRED SMOKE ALARMS. SUPPLY AND FIT WHERE INDICATED ON PLAN, TO BCA 3.7.2 REQUIREMENTS. SMOKE ALARMS MUST BE INTERCONNECTED WHERE THERE IS MORE THAN ONE ALARM.

> GRATE DRAIN TO GARAGE DOOR OPENING TO DIRECT ALL STORMWATER AWAY FROM BUILDING OPENING, TO S/W SYSTEM

CONCRETE OR PAVED PATH / DRIVEWAY TO ALL ACCESS DOORS TO DWELLING ALL DRIVEWAYS, PATIOS & PATHS ARE TO BE CONSTRUCTED TO DIRECT SAW AWAY FROM DWELLING @ 1:50 MINIMUM GRADE AND HAVE A MAX STEP HEIGHT OF 180mm



BRICK COLUMNS - 350x350 89x89x5 DURAGAL COLUMN - LOAD BEARING INSIDE 350x350 BRICK COLUMN

STEEL COLUMN - 89x89x5 DURAGAL COLUMN




(H.W) HOT WATER CYLINDER

REVERSE CYCLE HEAT PUMP INDOOR UNIT

H.P REVERSE CYCLE HEAT PUMP OUTDOOR UNIT

FLOOR COVERINGS AS PER CONTRACT SPECIFICATION BETWEEN OWNER AND BUILDER.

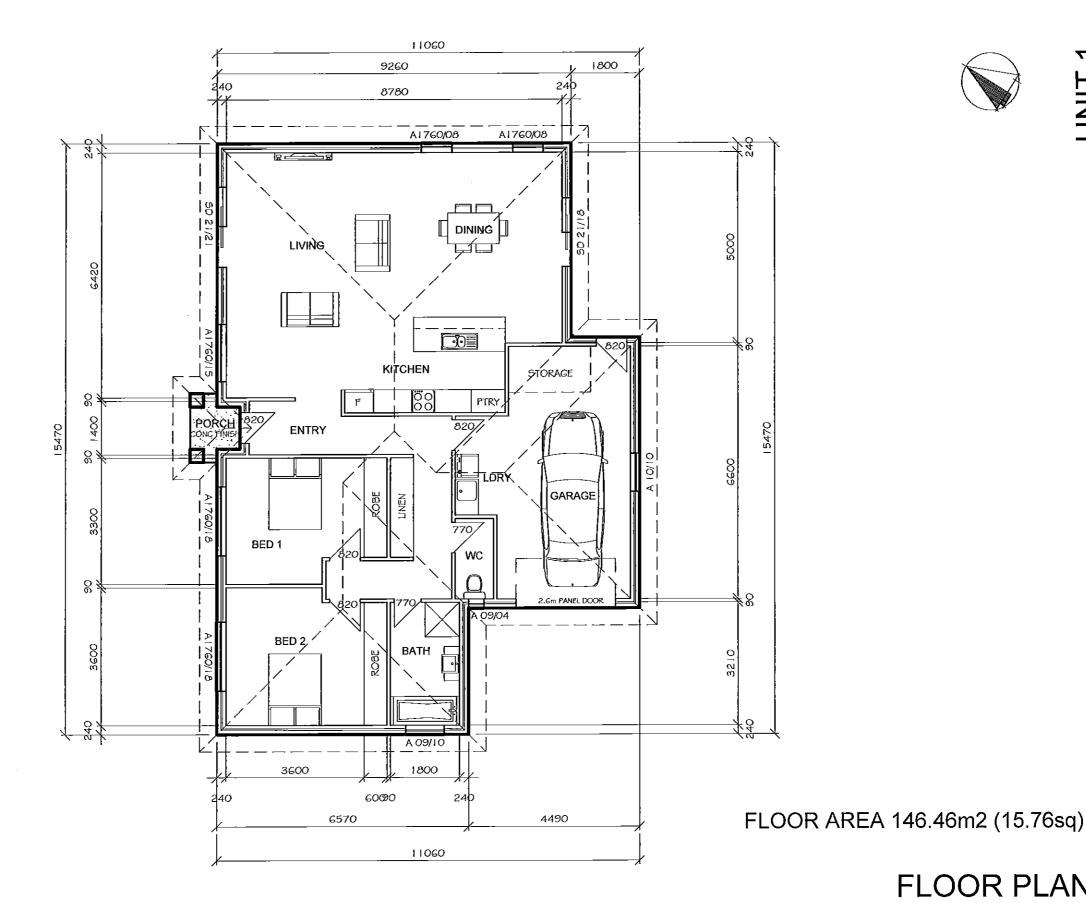

FLOOR PLAN

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PROPOSED UNIT DEVELOPMENT FOR: CHRIS REISSIG BUILDERS LOT: 20, NO. 5 LEGGES CRESCENT PROSPECT

sheet: 07 OF 29	ISSUE	drawing no: 6106	
date: DEC 2015	PLANNING	AMENDMENT No.	
scale: 1:100 @ A3	PRINT DATE	1.	
design: JVZ	0 C C C C C C C C C C C C C C C C C C C	2.	
drawn: JVZ	2 6 FEB 2016	3.	

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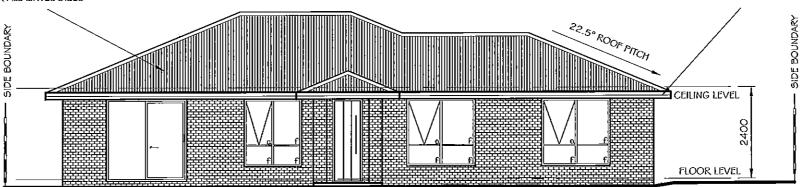


ROOF FRAMING (GREATER THAN 5 DEGREES) CUSTOM ORB OR SIMILAR APPROVED SHEET ROOFING COLORBOND COLOUR TO SELECTION, OVER ROOF BATTENS (TO AS1684.2) AND APPROVED ROOF TRUSSES INSTALLED STRICTLY IN ACCORDANCE WITH MANUFACTURERS RECOMMENDATIONS. ALL FIXING DETAILS TO BE ADHERED TO. SISILATE ROOF PRIOR TO SHEETING ALL TRUSS LOADS ARE TO BE DISTRIBUTED TO PERIMETER WALLS ONLY - UNLESS OTHERWISE SPECIFIED REFER TO ENGINEERS DETAILS FOR ALL LINTEL SIZES


EAVES OVERHANG ROOFS 450mm FRAME FOR LEVEL EAVES AND LINE WITH FLEXBOARD SHEETING

FASCIA

COLORBOND PRE - COATED FOLDED METAL GUTTER - FASCIA TRIM



NORTH ELEVATION

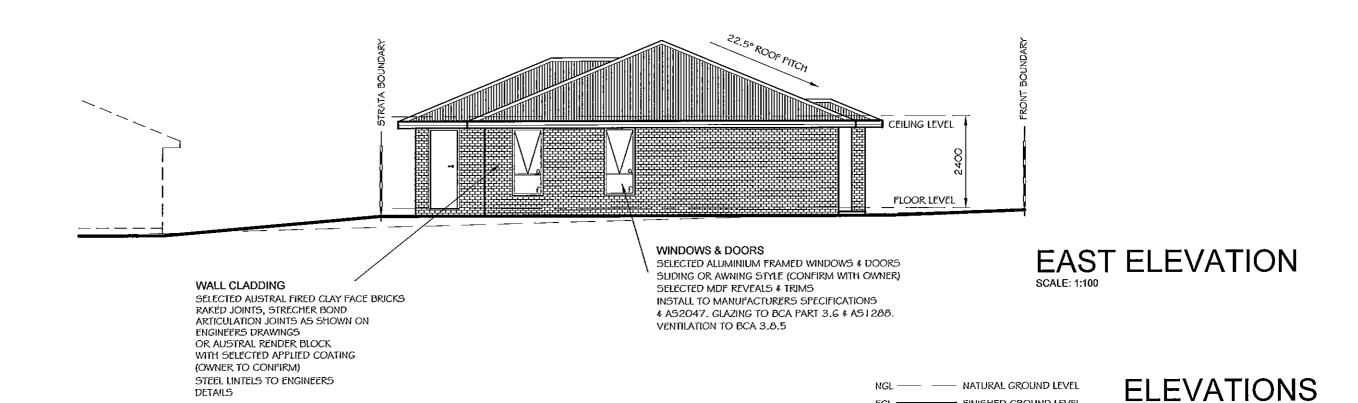

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DETAILS

sheet: 08 OF 29	ISSUE	dra
date: DEC 2015	PLANNING	ΑM
scale: 1:100 @ A3	PRINT DATE	1.
design: JVZ	2 6 FEB 2016	2.
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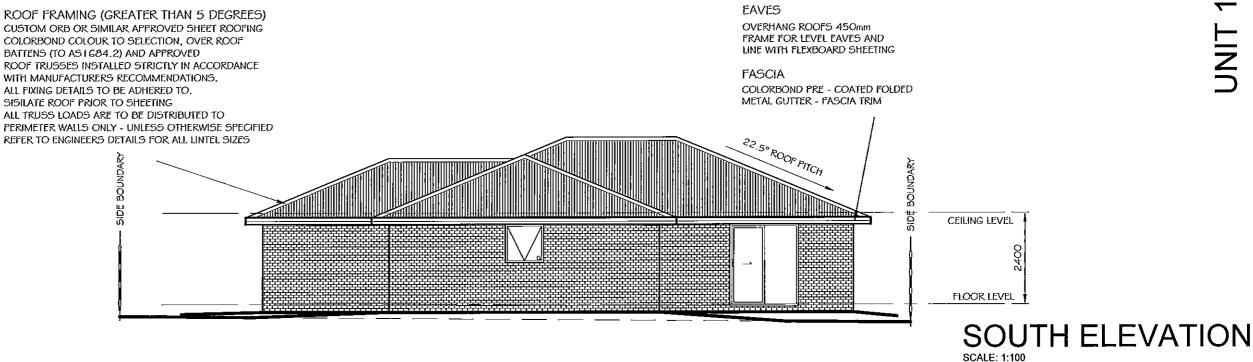
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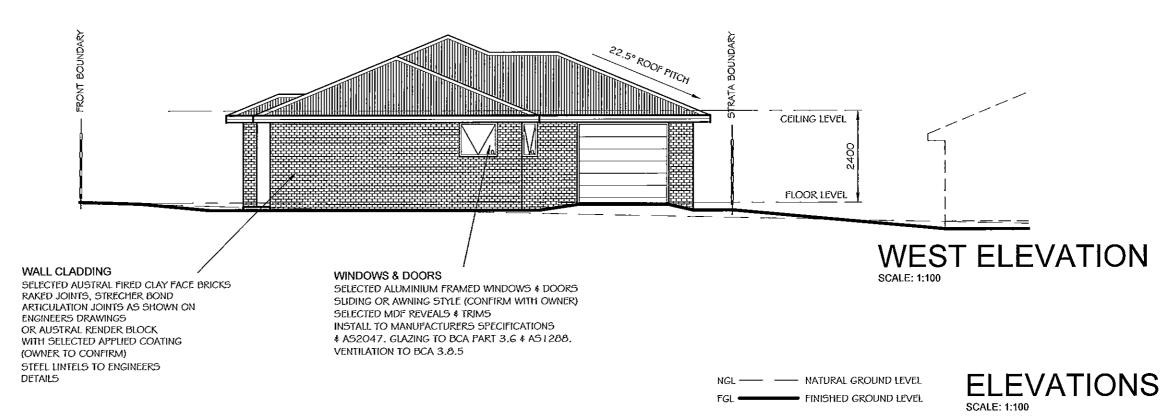
FINISHED GROUND LEVEL

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SCALE: 1:100





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PROPOSED UNIT DEVELOPMENT FOR: CHRIS REISSIG BUILDERS LOT: 20, NO. 5 LEGGES CRESCENT **PROSPECT**



sheet: 09 OF 29	ISSUE
date: DEC 2015	PLANNI
scale: 1:100 @ A3	PRINT DATE
design: JVZ	טיי בבנטיט
drawn: JVZ	2 6 FEB 2

drawing no: 6106 IING AMENDMENT No. 2016

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LEGEND

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LOCATION OF HARD-WIRED SMOKE ALARMS. SUPPLY AND FIT WHERE INDICATED ON PLAN, TO BCA 3.7.2 REQUIREMENTS. SMOKE ALARMS MUST BE INTERCONNECTED WHERE THERE IS MORE THAN ONE ALARM.

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BRICK COLUMNS - 350x350 89x89x5 DURAGAL COLUMN - LOAD BEARING INSIDE 350x350 BRICK COLUMN

STEEL COLUMN - 89x89x5 DURAGAL COLUMN



(H.W) HOT WATER CYLINDER

REVERSE CYCLE HEAT PUMP INDOOR UNIT

H.P REVERSE CYCLE HEAT PUMP OUTDOOR UNIT FLOOR COVERINGS AS PER CONTRACT SPECIFICATION BETWEEN OWNER AND BUILDER.

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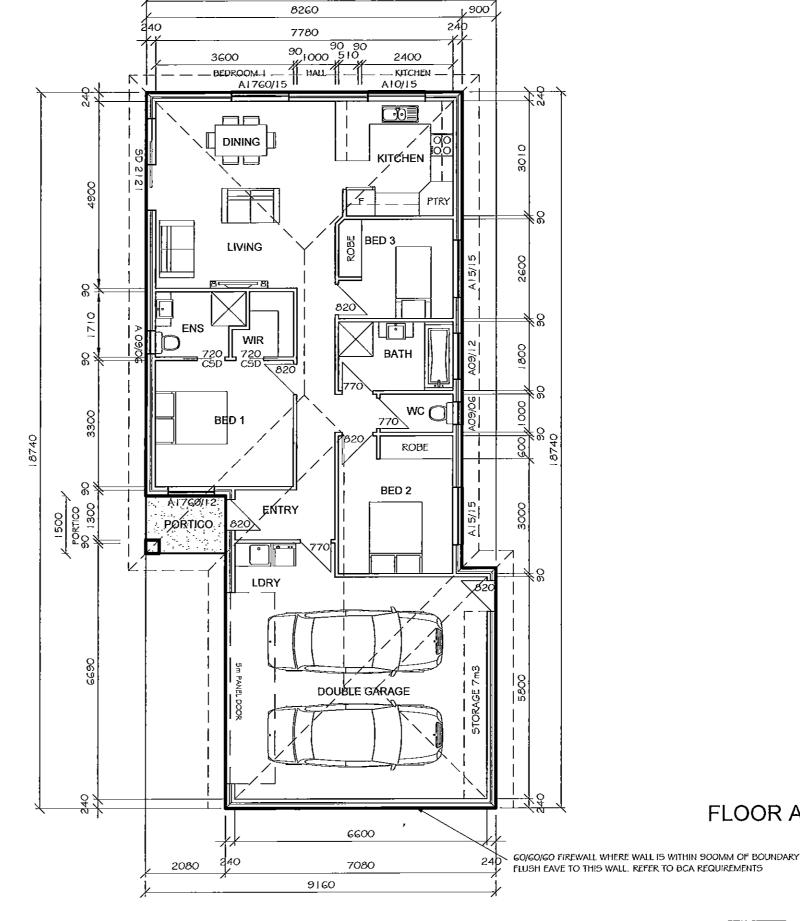


FLOOR AREA 143.45m2 (15.44sq)

FLOOR PLAN

design solutions





9160

LEGGES CRESCENT PERMISSION OF URBAN DESIGN SOLUTIONS **PROSPECT** / JASON VAN ZETTEN

DO NOT SCALE; IF IN DOUBT ASK

ENSURE FINISHED FLOOR LEVEL IS MINIMUM 150mm ABOVE FINISHED GROUND LEVEL

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STEEL COLUMN - 89x89x5 DURAGAL COLUMN




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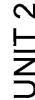



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9160

8260

FLOOR AREA 143.45m2 (15.44sq)

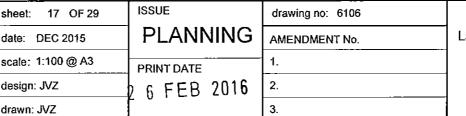FLOOR PLAN

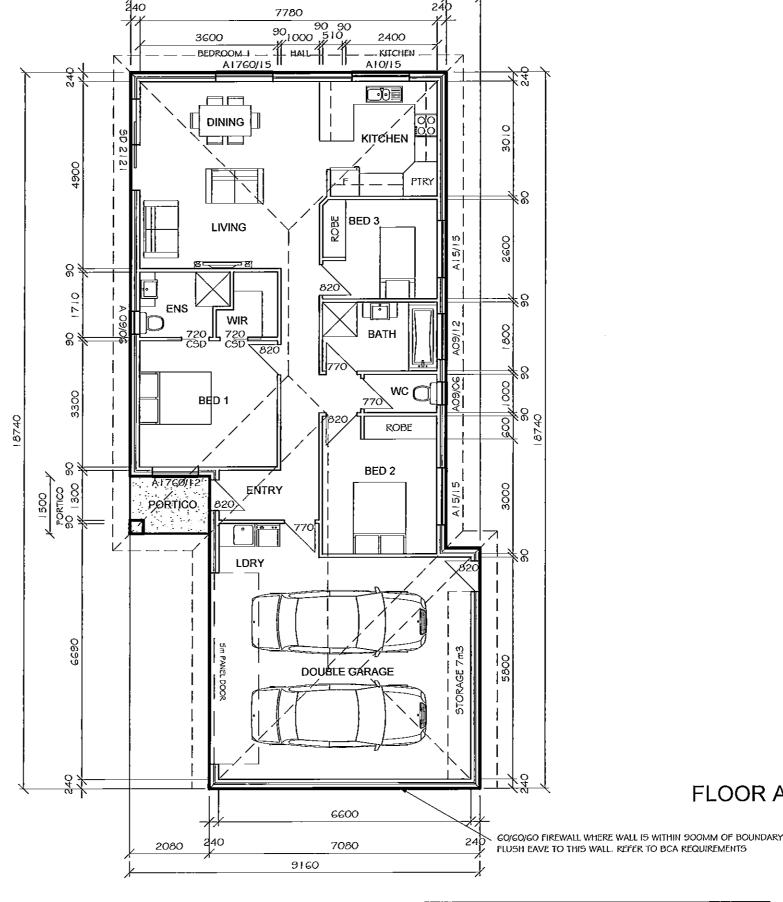

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LEGGES CRESCENT **PROSPECT**

ROOF FRAMING (GREATER THAN 5 DEGREES)
CUSTOM ORB OR SIMILAR APPROVED SHEET ROOFING
COLORBOND COLOUR TO SELECTION, OVER ROOF
BATTENS (TO AS I 684.2) AND APPROVED
ROOF TRUSSES INSTALLED STRICTLY IN ACCORDANCE
WITH MANUFACTURERS RECOMMENDATIONS.
ALL FIXING DETAILS TO BE ADHERED TO.
SISILATE ROOF PRIOR TO SHEETING
ALL TRUSS LOADS ARE TO BE DISTRIBUTED TO
PERIMETER WALLS ONLY - UNLESS OTHERWISE SPECIFIED
REFER TO ENGINEERS DETAILS FOR ALL LINTEL SIZES

GO/GO/GO FIREWALL WHERE WALL IS WITHIN 900MM OF BOUNDARY FLUSH EAVE TO THIS WALL, REFER TO BCA REQUIREMENTS

GO/GO/GO FIREWALL WHERE WALL IS WITHIN 900MM OF BOUNDARY FLUSH EAVE TO THIS WALL, REFER TO BCA REQUIREMENTS

OVERHANG ROOFS 450mm
FRAME FOR LEVEL EAVES AND LINE WITH FLEXBOARD SHEETING

FASCIA
COLORBOND PRE - COATED FOLDED METAL GUTTER - FASCIA TRIM


CEILING LEVEL

FLOOR LEVEL

FLOOR LEVEL

NORTH ELEVATION

EAVES

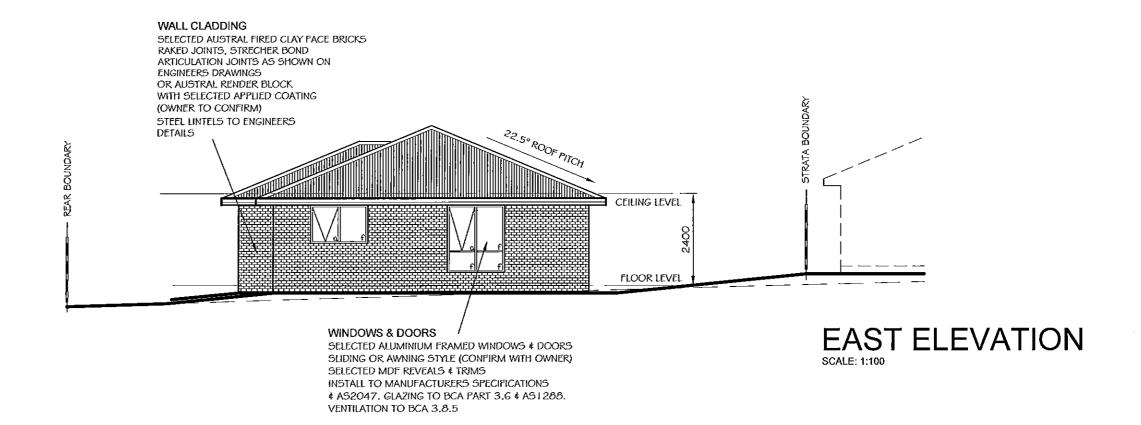

 ELEVATIONS

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PROSPECT

PLANNING EXHIBITI
DOCUMENTS

Not have DA 0072/2016

Common OS 03/2010/0

Pure of biometric DS 03/2010/0

Pure of biometric DS

sheet: 18 OF 29	ISSUE
date: DEC 2015	PLANNING
scale: 1:100 @ A3	PRINT DATE
design: JVZ	2 6 FEB 2018
drawn: IVZ	14 0 1 LD 7010

	drawing no: 6106
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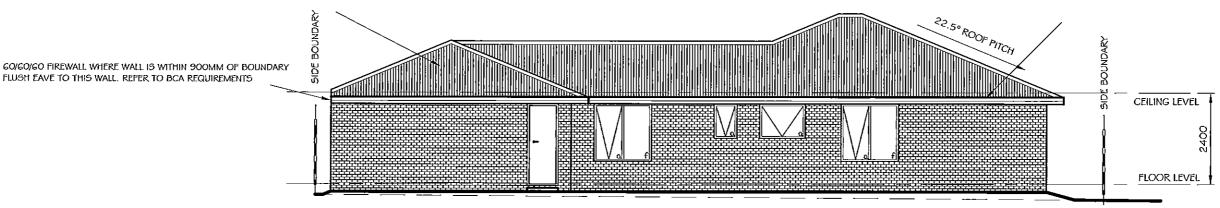


ROOF FRAMING (GREATER THAN 5 DEGREES)
CUSTOM ORB OR SIMILAR APPROVED SHEET ROOFING
COLORBOND COLOUR TO SELECTION, OVER ROOF
BATTENS (TO AS 1 684.2) AND APPROVED
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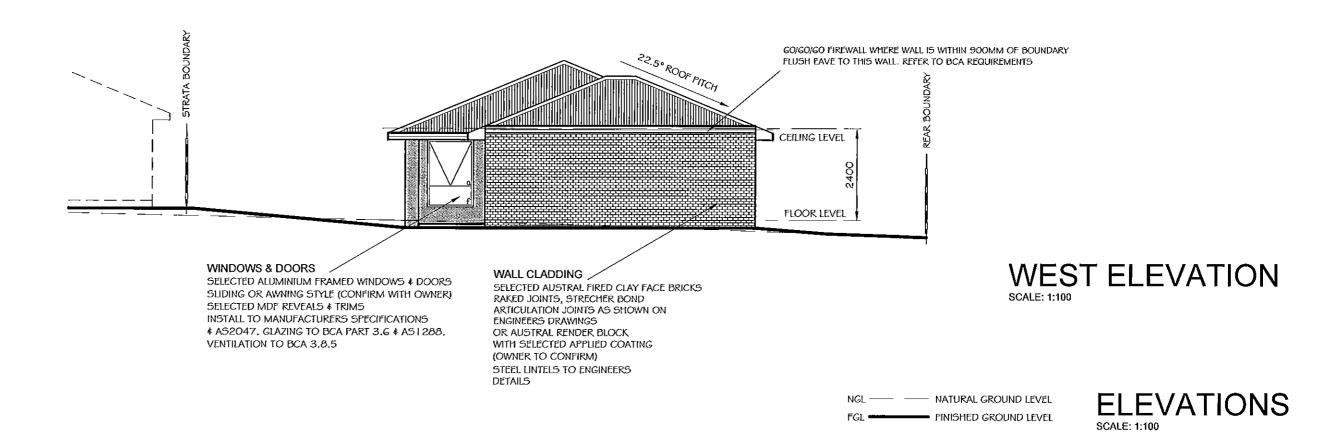
EAVES
OVERHANG ROOFS 450mm
FRAME FOR LEVEL EAVES AND
LINE WITH FLEXBOARD SHEETING

FASCIA

COLORBOND PRE - COATED FOLDED METAL GUTTER - FASCIA TRIM



SOUTH ELEVATION



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/ JASON VAN ZETTEN

PROPOSED UNIT DEVELOPMENT FOR: CHRIS REISSIG BUILDERS LOT: 20, NO. 5 LEGGES CRESCENT PROSPECT



sheet: 19 OF 29	ISSUE
date: DEC 2015	PLANNING
scale: 1:100 @ A3	PRINT DATE
design: JVZ	7, 6 550 301
drawn: JVZ	2 6 FEB 201

ı	drawing no: 6106
ANNING	AMENDMENT No.
DATE	1.
ED 2016	2.
FEB 2016	3.

Jason Van Zetten Acr.cc1952x

Launceston Office Phone 63 3444 089 PO BOX 7647 Launceston 7250 Email admin@urbantas.com.au





CHRIS REISSIG BUILDERS ETE

A.B.N. 33 109 862 660 A.C.N. 109 862 660 Master Builders Association – Reg. No. 3629 www.crbbuilders.com.au P.O. Box 27 PROSPECT Tas 7250 chrisreissig@bigpond.com Ph: 0407 971 852 Fax: 6340 1738

22nd February, 2016

Dear Planning,

Re: Lot 5, No.20 Legges Crescent Prospect.

Please find plans attached.

E6.6.2

- P1 -

We believe the plans are primarily compliant with the exception of car parking numbers. Our proposal includes 4 numbered car parking spaces, two set aside for each unit, without the acceptable solution of a fifth car parking space for visitor parking.

Due to the straight nature of the street, we believe there is sufficient visitor car parking space within the street reserve without hindering neighbors.

On each occasion we have visited the site there has been ample parking on the street.

Regards

Chris Reissig MANAGING DIRECTOR

CHRIS REISSIG BUILDERS P/L T/A – MZSR DEVELOPMENTS

PLANNING EXHIBITED DOCUMENTS

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