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Client: W. SYMONS

Project: PROPOSED DWELLING

Address: 7 ARGYLE STREET

WEST LAUNCESTON

Mob 0417 362 783 or 0417 545 813
jack@engineeringplus.com.au
trin@engineeringplus.com.au

Date Drawn: 15.1.15

Approved: J. Pfeiffer Scale: As Shown @ A3

Int: Accreditation No: CC2211T

A. Taylor

A. Taylor

Drawn:

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Rev: Amendment:

Checked:

15.1.15 A.T. Designer Name: J.Pfeiffer

HOUSE MOVED 1.0m (FRONT) 29.04.15 A.T. Accredited Building Designer/Architect Drawing No:

21314 - A01

Rev

В

NOTE
SEWER & STORMWATER FROM PROPOSED
DWELLING TO BE DIRECTED INTO EXISTING
SEWER & STORWATER SYSTEM TO LOCAL COUNCIL REQUIREMENTS & AS3500


SITE PLAN SCALE 1:200



(\$) - DENOTES SMOKE DETECTOR

SMOKE ALARMS PROVIDE AND INSTALL SMOKE ALARMS & HARD WIRE TO BUILDING POWER SUPPLY TO AS 3786. CEILING MOUNTED WITH 9VDC ALKALINE BATTERY BACKUP TO LOCATIONS INDICATED ON PLAN AND IN ACCORDANCE WITH BCA PART 3.7.2



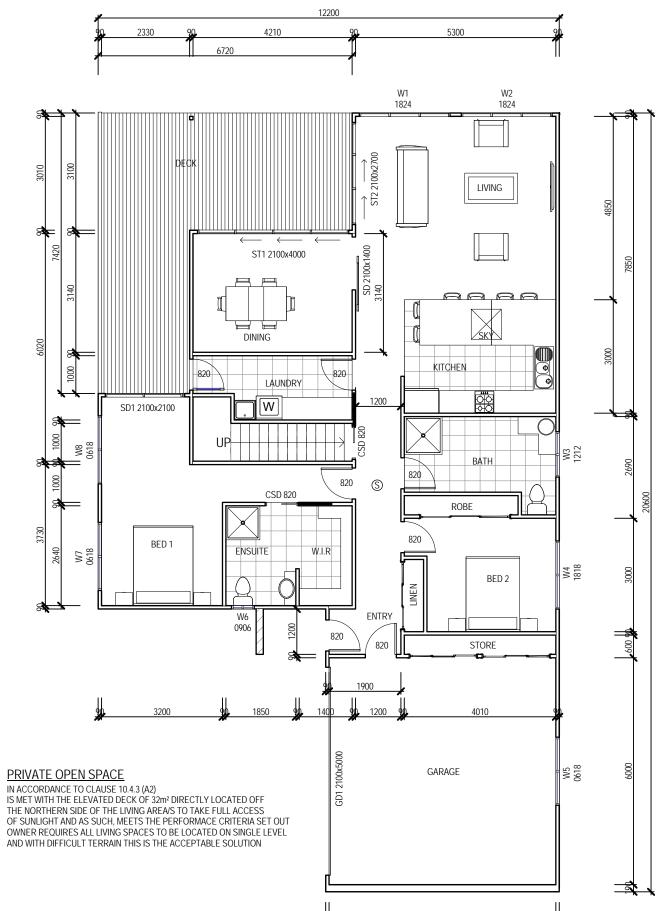

9780 5300

SUB FLOOR SCALE 1:100

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MARK	HEIGHT	WIDTH	TYP
W1	1800	2400	DG
W2	1800	2400	DG
W3	1200	1200	DG
W4	1200	1800	DG
W5	600	1800	DG
W6	600	600	DG
W7	600	1800	DG - FROSTED
W8	600	1800	DG - FROSTED
ST1	2100	4000	DG
ST2	2100	2700	DG
ST3	2100	2700	DG
SD1	2100	2100	DG

1180

WINDOW SCHEDULE

Area Schedule (Gross Building)				
Name	Area	Area (sq)		
FLOOR LEVEL	135.65 m²	14.60		
UPPER DECK	31.92 m²	3.44		
GARAGE	37.63 m²	4.05		
Sub Floor	55.24 m²	5.95		
	260.44 m ²	28.03		

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SCALE	1	: 10	0

				Date Drawn	: 15.1.15
				Drawn:	A. Taylor
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Accredited Building Designer/Architect | Drawing No: 15.1.15 A.T. Designer Name: J.Pfeiffer Int: Accreditation No: CC2211T

SKY

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21314 - A02

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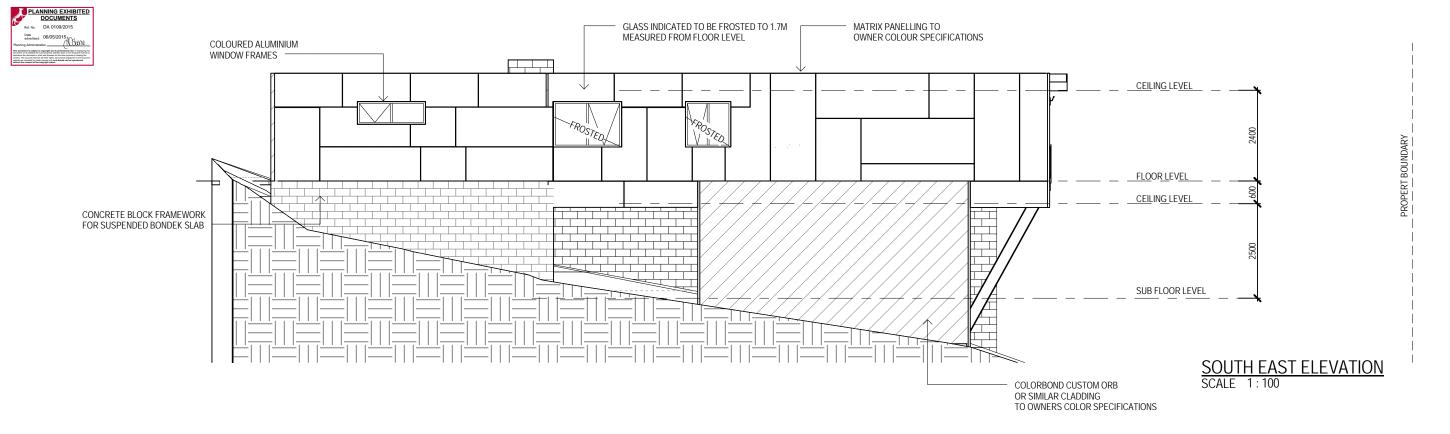
EAVE WIDTH - 300MM


DESIGN WIND SPEED N3

SOFFIT / EAVE LINED WITH 'HARDIFLEX' CEMENT SHEETING

- TRIMMERS LOCATED WITHIN 1200 MM OF EXTERNAL CORNERS TO BE SPACED @ 500 MM CENTERS, REMAINDER OF SHEET 700 MM CENTERS
- FASTENER / FIXINGS WITHIN 1200 MM OF EXTERNAL CORNERS @ 200 MM CENTERS, REMAINDER OF SHEET 300 MM CENTERS





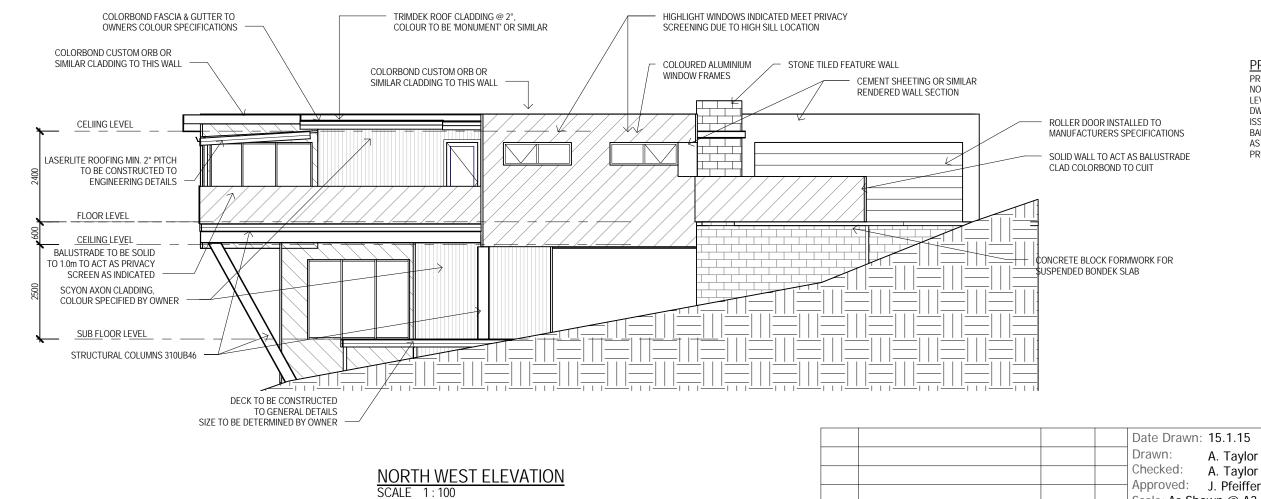

PRIVACY SCREENING (DECK)

PRIVACY SCREENING TO NORTH WEST DECK WILL NOT BE REQUIRED (CLAUSE 10.4.6) DUE TO THE FINISHED FLOOR LEVEL OF PROPOSED DWELLING BEING AT HEIGHT OF NEIGHBOURING DWELLING CEILING AND AS SUCH NO OVERLOOKING PRIVACY ISSUES INTO NEIGHBOURING DWELLING WILL BE PRESENT. BALUSTRADE TO BE SOLID TO 1.0m AS INDICATED WILL BE USED AS PRIVACY SCREEN PRIVACY SCREEN TO NORTH EAST SIDE OF DECK NOT REQUIRED

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Mob 0417 362 783 or 0417 545 813 **ENGINEERING** PLUS PROJECT MANAGEMENT CIVIL-STRECTURAL ENGIN


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Drawing No:

Rev - A03

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SELECTED ALUMINIUM FRAMED WINDOWS - BCA VOLUME 2 PART 3.6

POWDER COATED ALUMINIUM WINDOW & DOOR FRAMES, UNLESS OTHERWISE


TASMANIAN OAK REVEALS AND TRIMS. ALL FLASHING AND FIXINGS TO MANUFACTURERS SPECIFICATIONS.

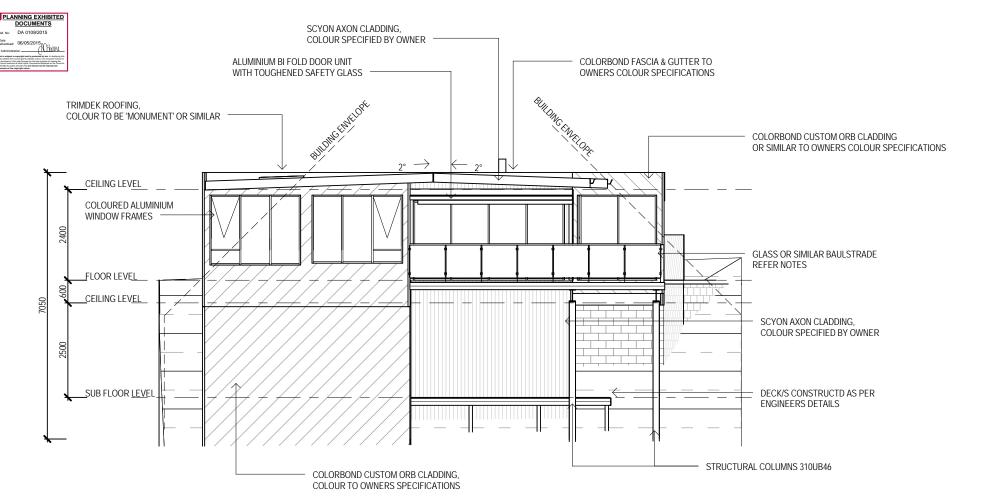GLAZING & FRAME CONSTRUCTION TO AS 2047 & AS 1288 ALL FIXINGS AND FLASHINGS TO MANUFACTURERS REQUIREMENTS

WIND CLASSIFICATION AS4055 WIND DESIGN: N3 4lm/s TERRAIN CATEGORY: T2 (NO SHIELDING)

SERVICEABILITY DESIGN & WIND PRESSURE: 1000 WATER RESISTANCE: 150

NORTH EAST ELEVATION

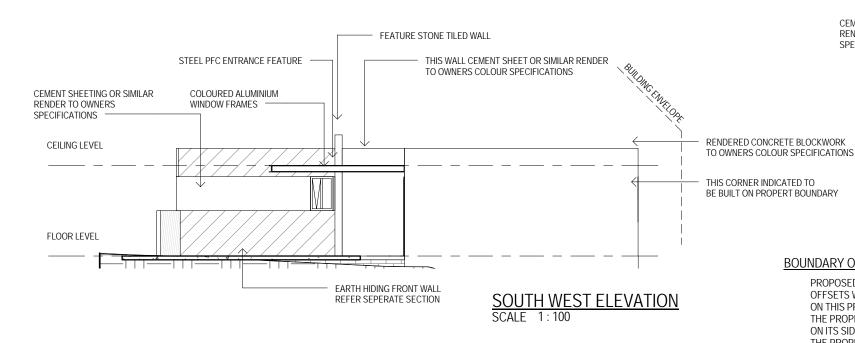

A MINIMUM OF 150 MM OF SUB FLOOR CLEARANCE IS TO BE PROVIDED BETWEEN FINISHED SURFACE LEVEL & THE UNDERSIDE OF THE FLOOR BEARER.

A MINIMUM OF 6000 MM2 PER METRE OF SUB FLOOR VENTILATION IS TO BE UNIFORMLY DISTRIBUTED AROUND THE EXTERNAL AND INTERNAL WALLS OF THE BUILDING.

STONE TILE FEATURE WALL COLOURED ALUMINIUM CEMENT SHEETING OR SIMILAR WINDOW FRAMES RENDERED TO THIS WALL CEMENT SHEETING OR SIMILAR RENDER TO OWNERS STEEL 180PFC OR SIMILAR SPECIFICATIONS CEILING LEVEL BUILDING FRANCE ENTRANCE FEATURE PARAPET WALL FLOOR LEVEL COLORBOND CUSTOM ORB CLADDING TO OWNERS COLOUR SPECIFICAITONS BONDEK SLAB

BOUNDARY OFFSETS

SOUTH WEST ELEVATION (1) SCALE 1:100

PROPOSED DWELLING IS BEING CONSTRUCTED OUTSIDE THE ACCEPTABLE BOUNDARY OFFSETS WHICH IS REQUIRED DUE TO THE DIFFICULT TERRAIN ENCOUNTERED ON THIS PROPERTY

THE PROPERTY LOCATED AT 4 ALFRED STREET HAS A CARPORT STRUCTURE LOACTED

ON ITS SIDE BOUNDARY WHICH IS ARGYLE STREET

THE PROPERTY LOCATED AT 2 ARGYLE STREET IS LOCATED WITHIN THE FROUNT BOUNDARY OFFSET WITH AN APPROX. DISTANCE OF 3.0m FROM BOUNDARY

GARAGE WALL LOCATED ON FRONT PROPERTY BOUNDARY IS REQUIRED DUE TO THE TERRAIN AND ANY SETBACK WILL RESULT IN THE DWELLING BEING PUSHED FURTHER DOWN THE PROPERTY TO STEEPER TERRAIN. MAIN DWELLING (EXCLUDING GARAGE) HAS 6.0m OFFSET FROM FRONT BOUNDARY

THE PERFORMANCE CRITERIA HAVE BEEN MET WITH THE MAIN ISSUE OF A STEEP/DIFFICULT TERRAIN REQUIRING THE DWELLING TO BE CITED AS SHOWN

Date Drawn: 15.1.15 Drawn: A. Taylor Checked: A. Taylor Approved: J. Pfeiffer Scale: As Shown @ A3 HOUSE MOVED 1.0m (FRONT) 29.04.15 A.T. Accredited Building Designer/Architect

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Drawing No:

- A04

ADDITIONAL VENTILATION PROVISIONS TO BE INSTALLED WHERE OBSTRUCTIONS SUCH AS CONCRETE VERANDAH'S, DECKS, PATIOS AND PAVING ARE INSTALLED & OBSTRUCT VENTILATION.

PRYDA 230X75 - 52 HOLE VENT MAXIMUM SPACING 1050 MM ALONG WALL OR

PRYDA 230x165 - 117 HOLE VENT MAXIMUM SPACING 2350 MM ALONG WALL

VENTS TO BE LOCATED NO GREATER THAN 600 MM FROM AN INTERNAL OR EXTERNAL CORNER

SUB FLOOR VENTILATION. BCA VOLUME 2 PART 3.4.1.


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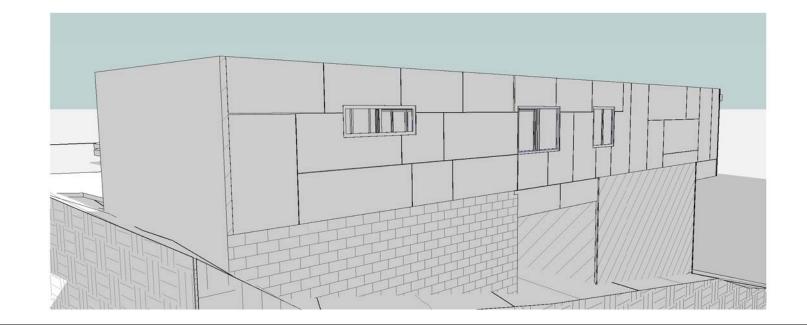
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JUNE 21 9.00am SCALE 1:300









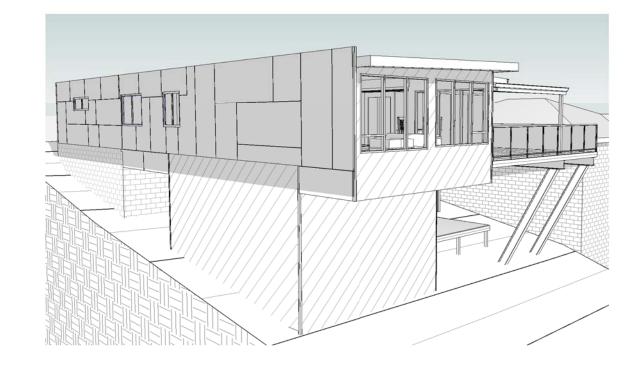

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A. Taylor

J. Pfeiffer

Drawn:

Checked:

Approved:

15.1.15 A.T. Designer Name: J.Pfeiffer

OVERSHADOWING

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PRIVATE OPEN SPACE LOCATED ON THE ELEVATED DECK TO THE NORTH IS VIRTUALLY FREE OF SHADOWS FROM NEIGHBOURING DWELLING AS THE FINISHED FLOOR LEVEL IS CLOSE TO ROOF LEVEL OF NEIGHBOURING PROPERTY

NEIGHBOURING PROPERTY TO THE SOUTH IS CURRENT VACANT AND AS SUCH HAS NO IMPACT ON THAT PROPERTY

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PLUS PRIZERO DEBUGN
PRIZERO TRANSCOMEN
TOTAL PRIZERO
TOTAL

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